
PAVING	3 SCHE	DULE					
KEY		ITEM/DESCRIPTION	COLOR	DETAIL/SHEET	FINISH	SUPPLIER	COMMENTS
	P-01	PORPHYRY GRECA DETAIL (AT CONCRETE ACCENT PLAZAS)	RED BLEND PORPHYRY	1 / LANDSCAPE SITE DETAILS SHEET 1	12" X 12", SQUARE, SQ. PATTERN	MILESTONE IMPORTS	SEE DETAIL & ENLARGEMENT PLANS. SEE PORPHYRY PAVING SPEC.
	P-02	PORPHYRY PAVING (AT WALKWAY)	RED BLEND PORPHYRY	2 / LANDSCAPE SITE DETAILS SHEET 1	4" X 4" SQUARE PATTERN	MILESTONE IMPORTS	SEE DETAIL & ENLARGEMENT PLANS. SEE PORPHYRY PAVING SPEC.
	P-01	CONCRETE ACCENT PLAZA FIELD (MID-BLOCK)	SCOFIELD "SOMBRERO BUFF"	1 / LANDSCAPE SITE DETAILS SHEET 1	TOPCAST, SEE SPECS. 12" GRID.	GCP (TOPCAST), DAVIS COLOR	SEE DECORATIVE CONCRETE FINISHES SPEC
	P-02	CONCRETE GRECA DETAIL (WALKWAY)	SCOFIELD "SOMBRERO BUFF"	2 / LANDSCAPE SITE DETAILS SHEET 1	TOPCAST, SEE SPECS. 12" GRID.	GCP (TOPCAST), DAVIS COLOR	SEE DECORATIVE CONCRETE FINISHES SPEC
	P-05	CONCRETE PAVING (SIDEWALK)	GREY, CoSA STANDARD	1 / LANDSCAPE SITE DETAILS SHEET 2	TOPCAST, SEE SPECS. 24" GRID	GCP (TOPCAST)	SEE DECORATIVE CONCRETE FINISHES SPEC
	<b>P-05</b> SIM	CONCRETE PAVING (ON-STREET PARKING)	GREY, CoSA STANDARD	SEE CIVIL DWGS FOR VEHICULAR PAVING	TOPCAST, SEE SPECS. 24" GRID	GCP (TOPCAST)	SEE DECORATIVE CONCRETE FINISHES SPEC
	P-06	PORPHYRY PAVING (CROSSWALK)	RED BLEND PORPHYRY	2 / LANDSCAPE SITE DETAILS SHEET 2	4" X 4" CUBES, ARC FIELD+GRID BANDS	MILESTONE IMPORTS	SEE DETAIL & ENLARGEMENT PLANS. SEE PORPHYRY PAVING SPEC.
	P-09	CRUSHED STONE MULCH	LIGHT TAN / BROWN	3 / LANDSCAPE SITE DETAILS SHEET 2	DECOMPOSED GRANITE	COLLIER MATERIALS	SEE CRUSHED STONE SPECS
		CONCRETE PAVING, CYCLE TRACK (SEE CIVIL DRAWINGS)	GREY, CoSA STANDARD	SEE CIVIL DRAWINGS	CoSA STANDARD		SEE CIVIL DRAWINGS

KEY		ITEM/DESCRIPTION	COLOR	DETAIL/SHEET	FINISH	SUPPLIER	COMMENTS
	A-01	CHAIR (BACKED AND BACKLESS)	THERMALLY MODIFIED ASH (DSTMA) SEAT	1 / LANDSCAPE SITE DETAILS SHEET 3	DSTMA WOOD SEAT, ALUMINUM	LANDSCAPE- FORMS	SEE SITE FURNISHING SPECS
	A-02	BENCH (LIMESTONE BLOCK)	TEXAS LIMESTONE, CREAM COLOR	2 / LANDSCAPE SITE DETAILS SHEET 3	STONE FINISHES TOP: MACHINE SMC ALL FACES: MACHIN BOTTOM EDGE: SAV ALL OTHER EDGES:	IE SMOOTH/HONED FINISH	SEE STONE MASONRY SPECS
(e)	A-05	BOLLARD TYPE 1	"JAGUAR TOPAZ"	3 / LANDSCAPE SITE DETAILS SHEET 3	POWDER COAT	FAIR- WEATHER	SEE SITE FURNISHING SPECS
•	A-06	BOLLARD TYPE 2 (REMOVABLE)	"JAGUAR TOPAZ"	4/ LANDSCAPE SITE DETAILS SHEET 3	POWDER COAT	FAIR- WEATHER	SEE SITE FURNISHING SPECS
<b>(4)</b>	A-08	BIKE RACK	"SILVER TEXTURE"	5 / LANDSCAPE SITE DETAILS SHEET 3	POWDER COAT	FORMS + SURFACES	SEE SITE FURNISHING SPECS
00	A-09	TRASH & RECYCLING BIN	CITY STANDARD	6 / LANDSCAPE SITE DETAILS SHEET 3	POWDER COAT	VICTOR STANLEY SD-42	SEE SITE FURNISHING SPECS
		VIA BUS SHELTER		1 / LANDSCAPE SITE DETAILS SHEET 4			VIA STANDARD SHELTER
(*)		PEDESTRIAN LIGHT (SEE ILLUMINATION PLAN)		SEE ELECTRICAL DRAWINGS			SEE ELECTRICAL DRAWINGS FOR PRODUCT INFORMATION.


### **GENERAL NOTES:**


- ALL WORK SHALL BE PERFORMED IN ACCORDANCE WITH DRAWINGS APPROVED BY THE CITY OF SAN ANTONIO.
- BASE INFORMATION PROVIDED BY CIVIL ENGINEER. REFER TO SURVEY, PLAT, ROADWAY AND UTILITY DRAWINGS, AND OTHER AVAILABLE DOCUMENTS FOR PROPERTY LIMITS, EXISTING CONDITIONS, PROPOSED UTILITIES AND HORIZONTAL AND VERTICAL CONTROL.
- 3. THE LIMITS OF WORK OCCUR AT THE PROPERTY LINE OR AS SHOWN ON PLANS.
- 4. VERIFY EXISTING SITE CONDITIONS INCLUDING, WALLS, VEGETATION FENCES, UTILITIES, PROPERTY LINES, LIMITS OF ROADWAYS, CURBS AND GUTTERS, AND OTHER OBSTRUCTIONS THAT MAY AFFECT THE PROGRESS OF WORK.
- LOCATE UTILITIES AND MAINTAIN THEIR LOCATION DURING ALL PHASES OF WORK. DO NOT DAMAGE UTILITY LINES/STRUCTURES. NOTIFY ENGINEER OF ANY DISCREPANCIES BEFORE STARTING ANY WORK. CONTRACTOR SHALL BE RESPONSIBLE FOR LOCATION AND PROTECTION OF UNDERGROUND UTILITIES OR STRUCTURES, WHETHER OR NOT SHOWN OR DETAILED AND INSTALLED BY ANY OTHER CONTRACT. RESTORATION OF UTILITIES DAMAGED BY THE CONTRACTOR SHALL BE AT THE CONTRACTOR'S EXPENSE.
- 6. THOROUGHLY REVIEW THE SITE CONDITIONS, DRAWINGS, AND TECHNICAL SPECIFICATIONS PRIOR TO CONSTRUCTION. COMPLETE THE WORK OF THIS PROJECT IN ACCORDANCE WITH APPROVED DRAWINGS.
- 7. ANYTHING MENTIONED IN THE TECHNICAL SPECIFICATIONS AND NOT SHOWN ON THE DRAWINGS, OR SHOWN ON THE DRAWINGS AND NOT MENTIONED IN THE TECHNICAL SPECIFICATIONS SHALL BE OF LIKE EFFECT AS IF SHOWN ON OR MENTIONED IN BOTH.
- 8. CONSTRUCTION INSTALLATION, MATERIALS, TESTING AND INSPECTION SHALL COMPLY WITH APPLICABLE CODES, ORDINANCES, AND SPECS.
- 9. TAKE NECESSARY STEPS TO PROTECT AND MAINTAIN ALL FINISHED WORK FOR THE DURATION OF THE CONTRACT UNTIL FINAL ACCEPTANCE.
- 10. THESE DRAWINGS DO NOT SPECIFY SAFETY MATERIALS, EQUIPMENT, METHODS OR SEQUENCING TO PROTECT PERSONS AND PROPERTY. DIRECT AND IMPLEMENT SAFETY OPERATIONS AND PROCEDURES TO PROTECT THE OWNER, OTHER CONTRACTORS, THE PUBLIC, AND OTHERS FOR THE DURATION OF THE CONTRACT.
- 11. NOTES AND DETAILS ON SPECIFIC DRAWINGS TAKE PRECEDENCE OVER GENERAL NOTES AND TYPICAL DETAILS.
- 12. OBTAIN NECESSARY PERMITS FROM ALL JURISDICTIONS AS REQUIRED TO CONSTRUCT THE WORK OF THIS PROJECT.
- 13. THE WORK OF THIS CONTRACT WILL NOT BE CONSIDERED COMPLETE UNTIL ALL AREAS HAVE BEEN CLEANED OF ALL DIRT AND DEBRIS AND ALL DAMAGED ITEMS ARE REPAIRED.

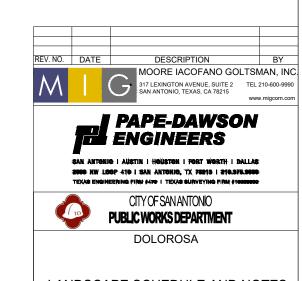



LANDSCAPE SCHEDULE AND NOTES


DESIGN	CHECKED	DRAWN	PROJECT NO.	SUBMITTAL	SHEET NO.	
RD/AM	RD/AM	TM/RD	23-03763	70%	315	

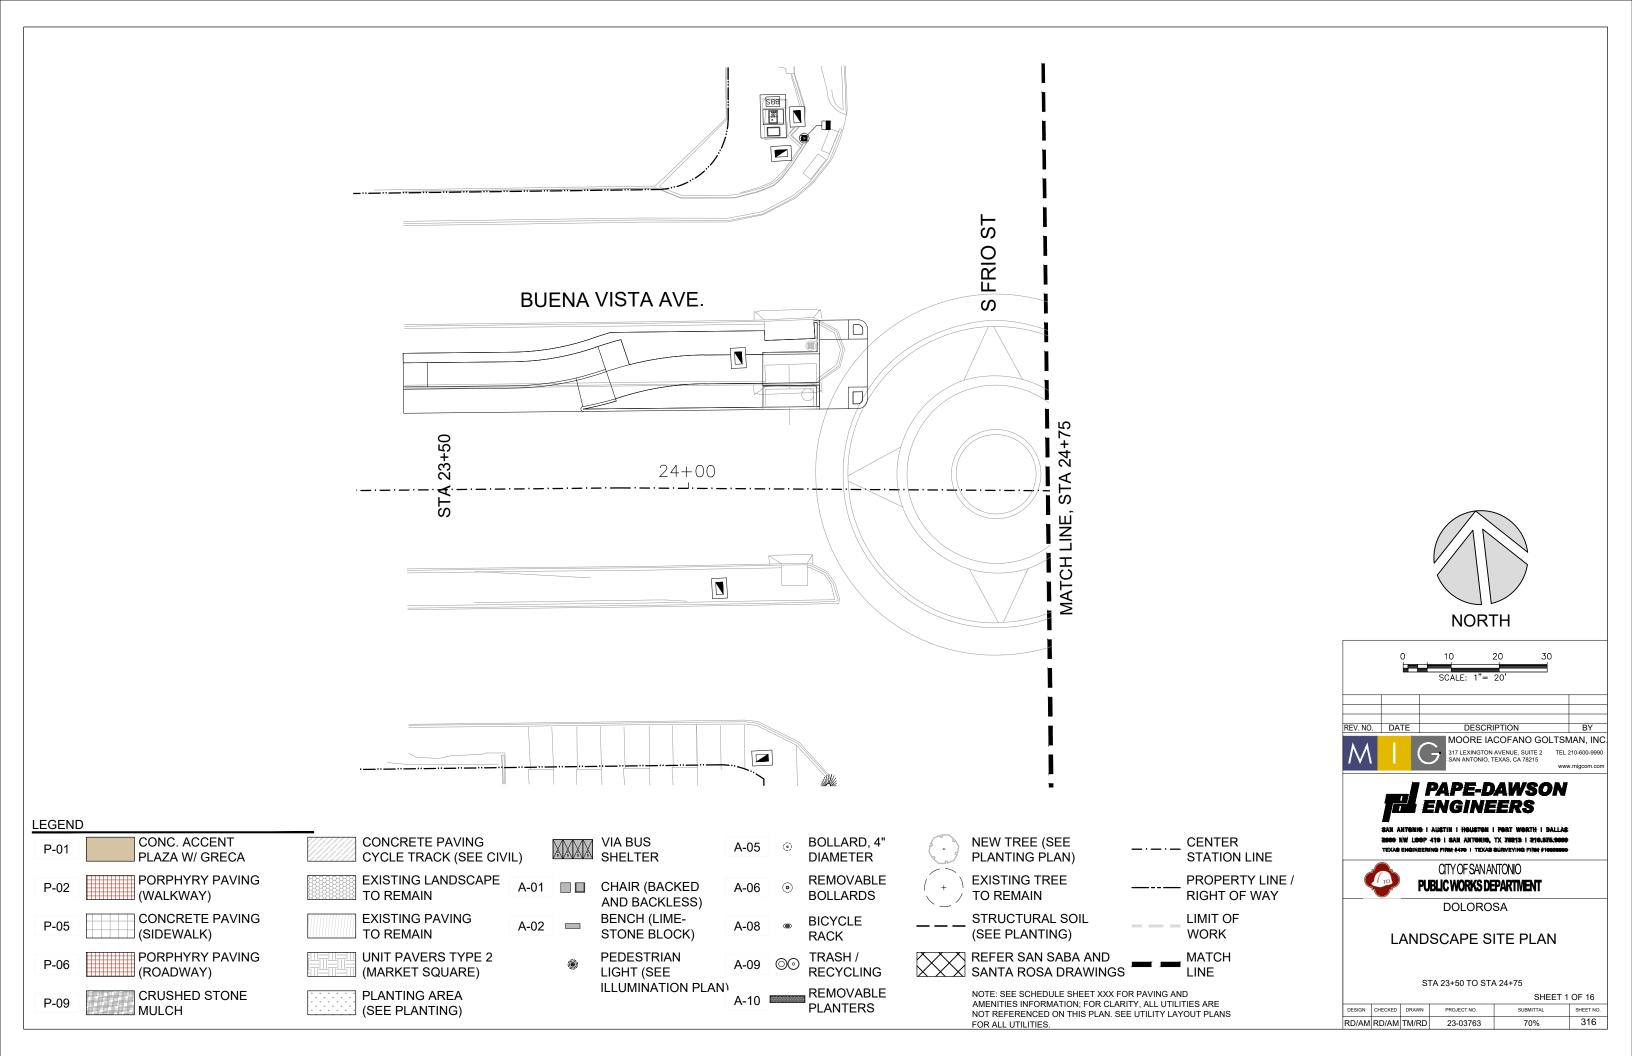

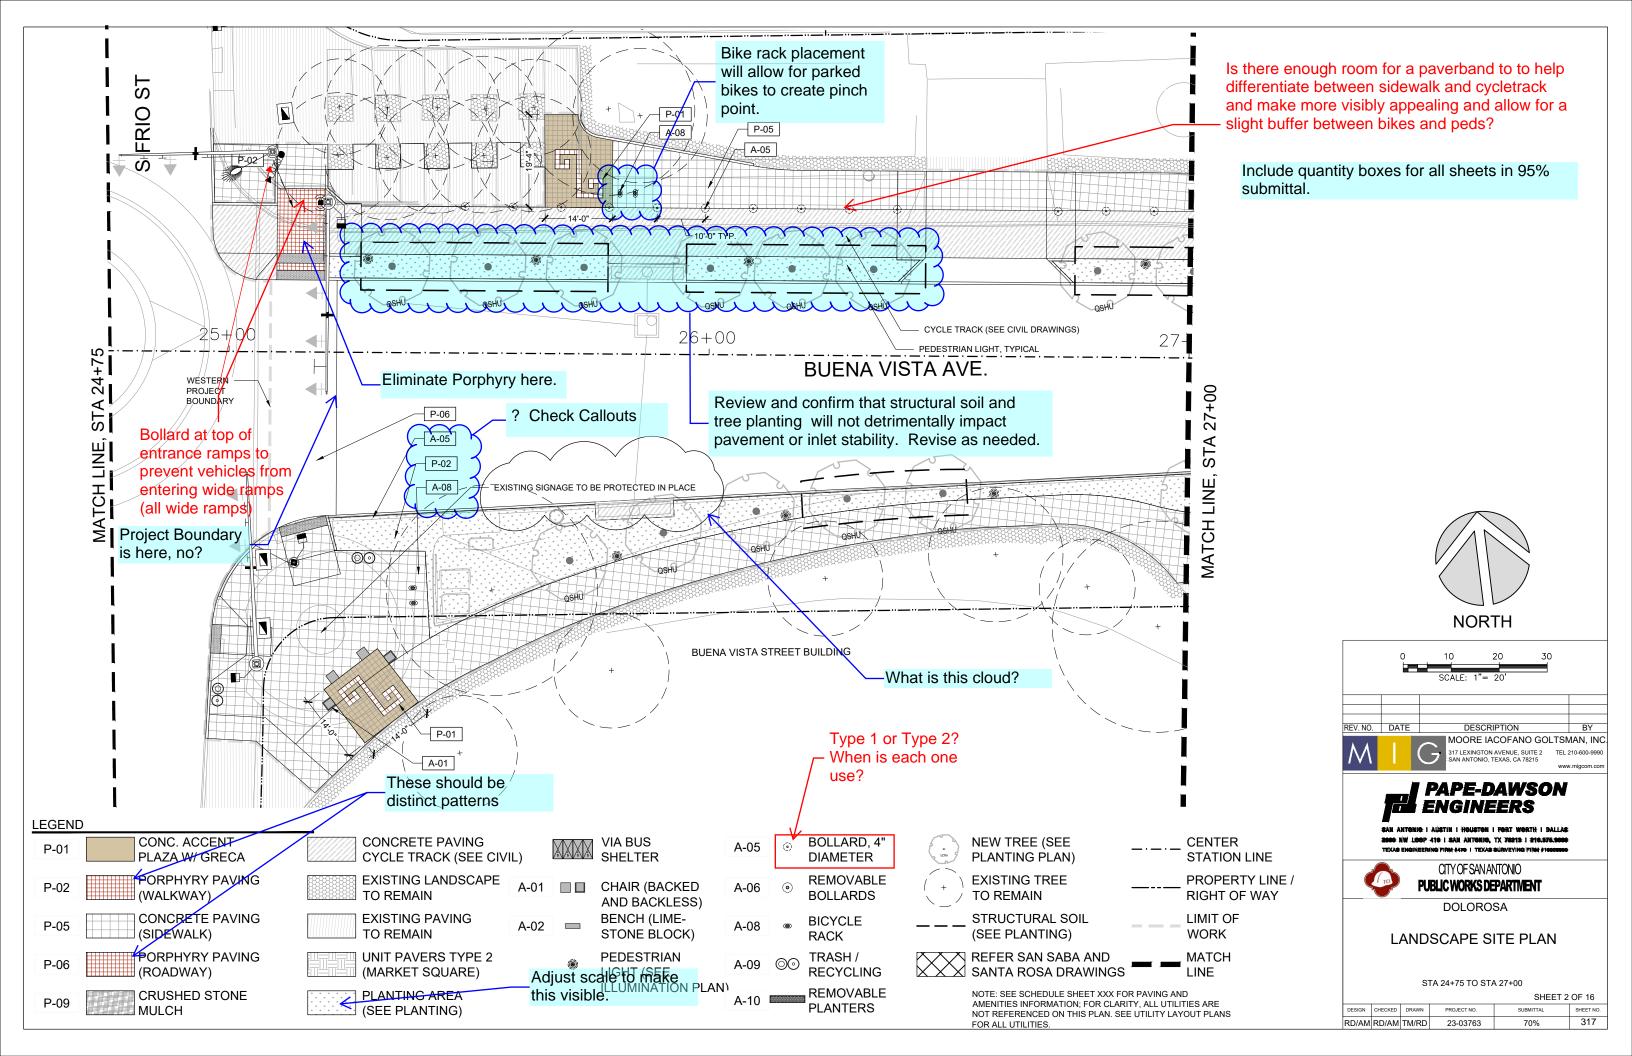

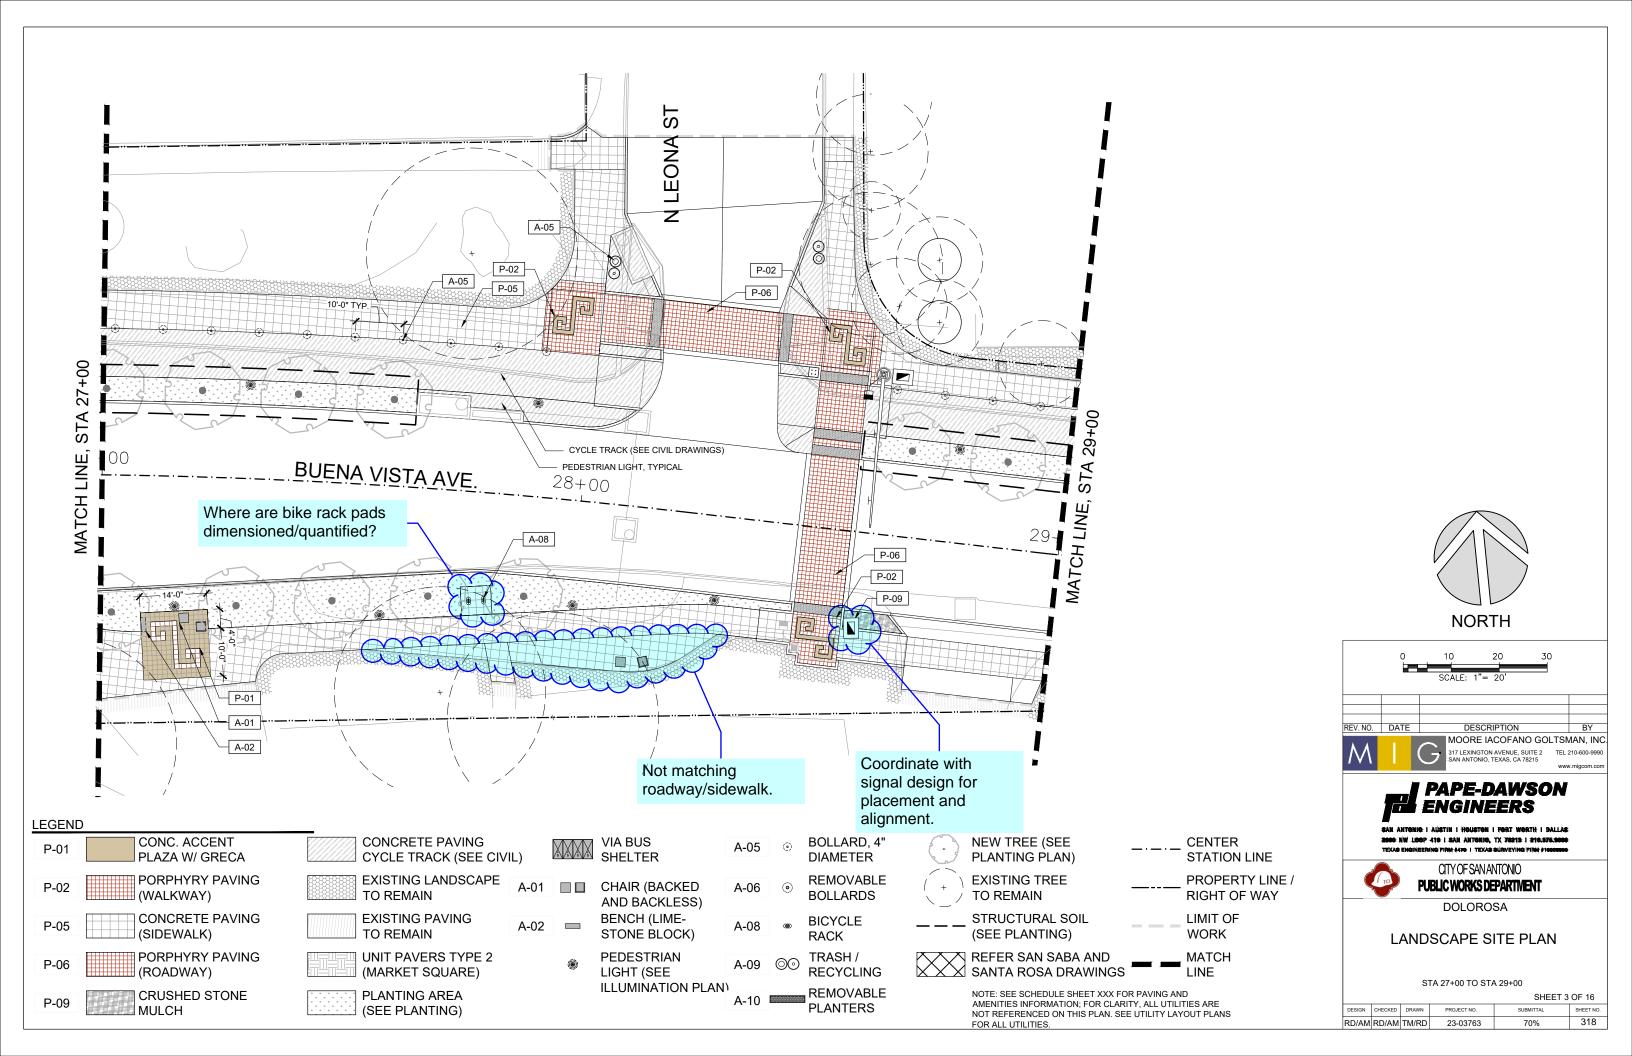


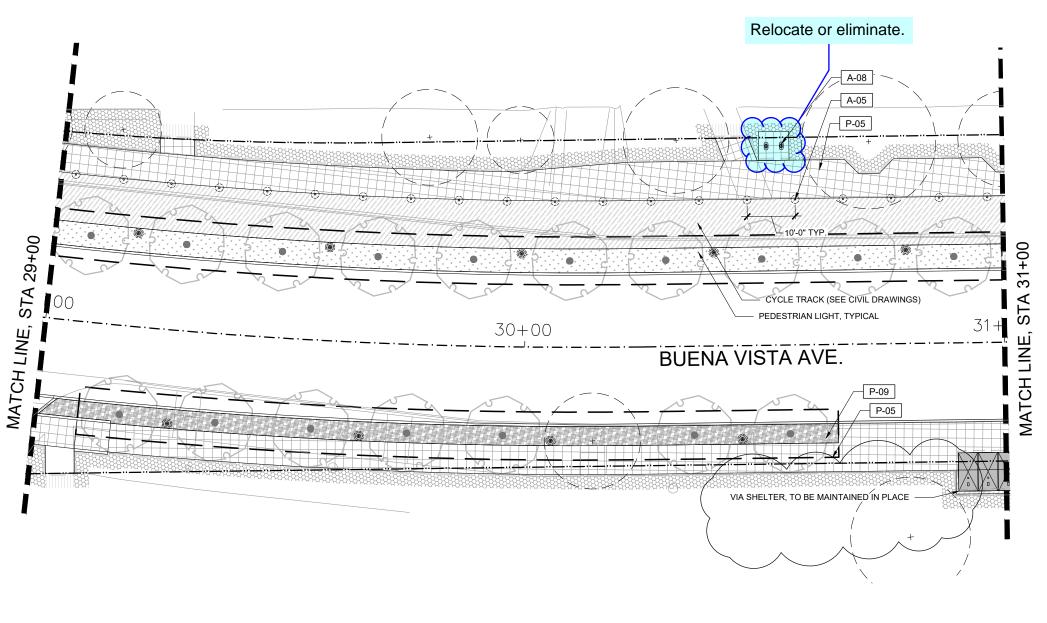

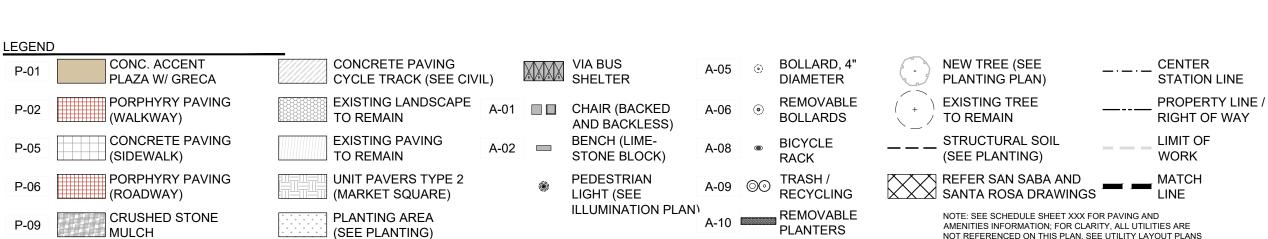



### **NORTH**

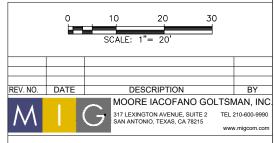

# PAPE-DAWSON ENGINEERS

SAN ANTONIO: I AUSTIN I HOUSTON I PORT WORTH I DALLAS 2000 NW LOOP 416 I SAN ANTONIO, TX 78213 I 210.375.0001




CITY OF SAN ANTONIO
PUBLIC WORKS DEPARTMENT


DOLOROSA


LANDSCAPE SITE PLAN


STA 29+00 TO STA 31+00


				SHEET 4 OF 10		
DESIGN	CHECKED	DRAWN	PROJECT NO.	SUBMITTAL	SHEET NO.	
RD/AM	RD/AM	TM/RD	23-03763	70%	319	

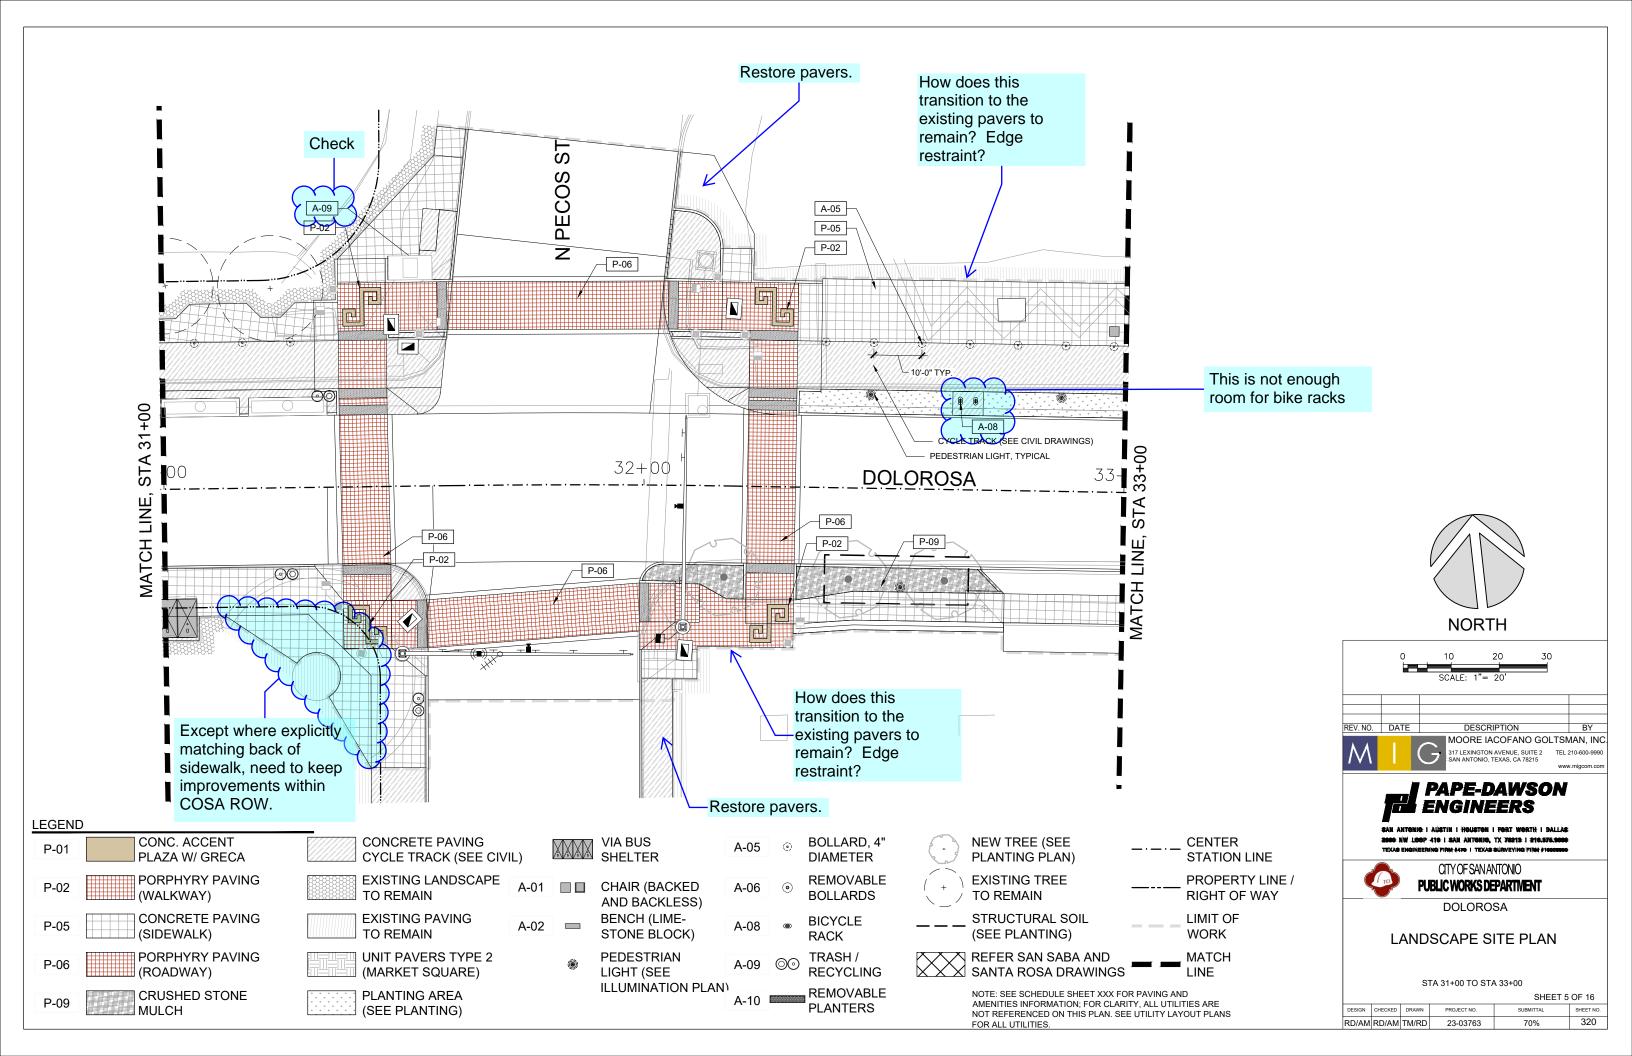

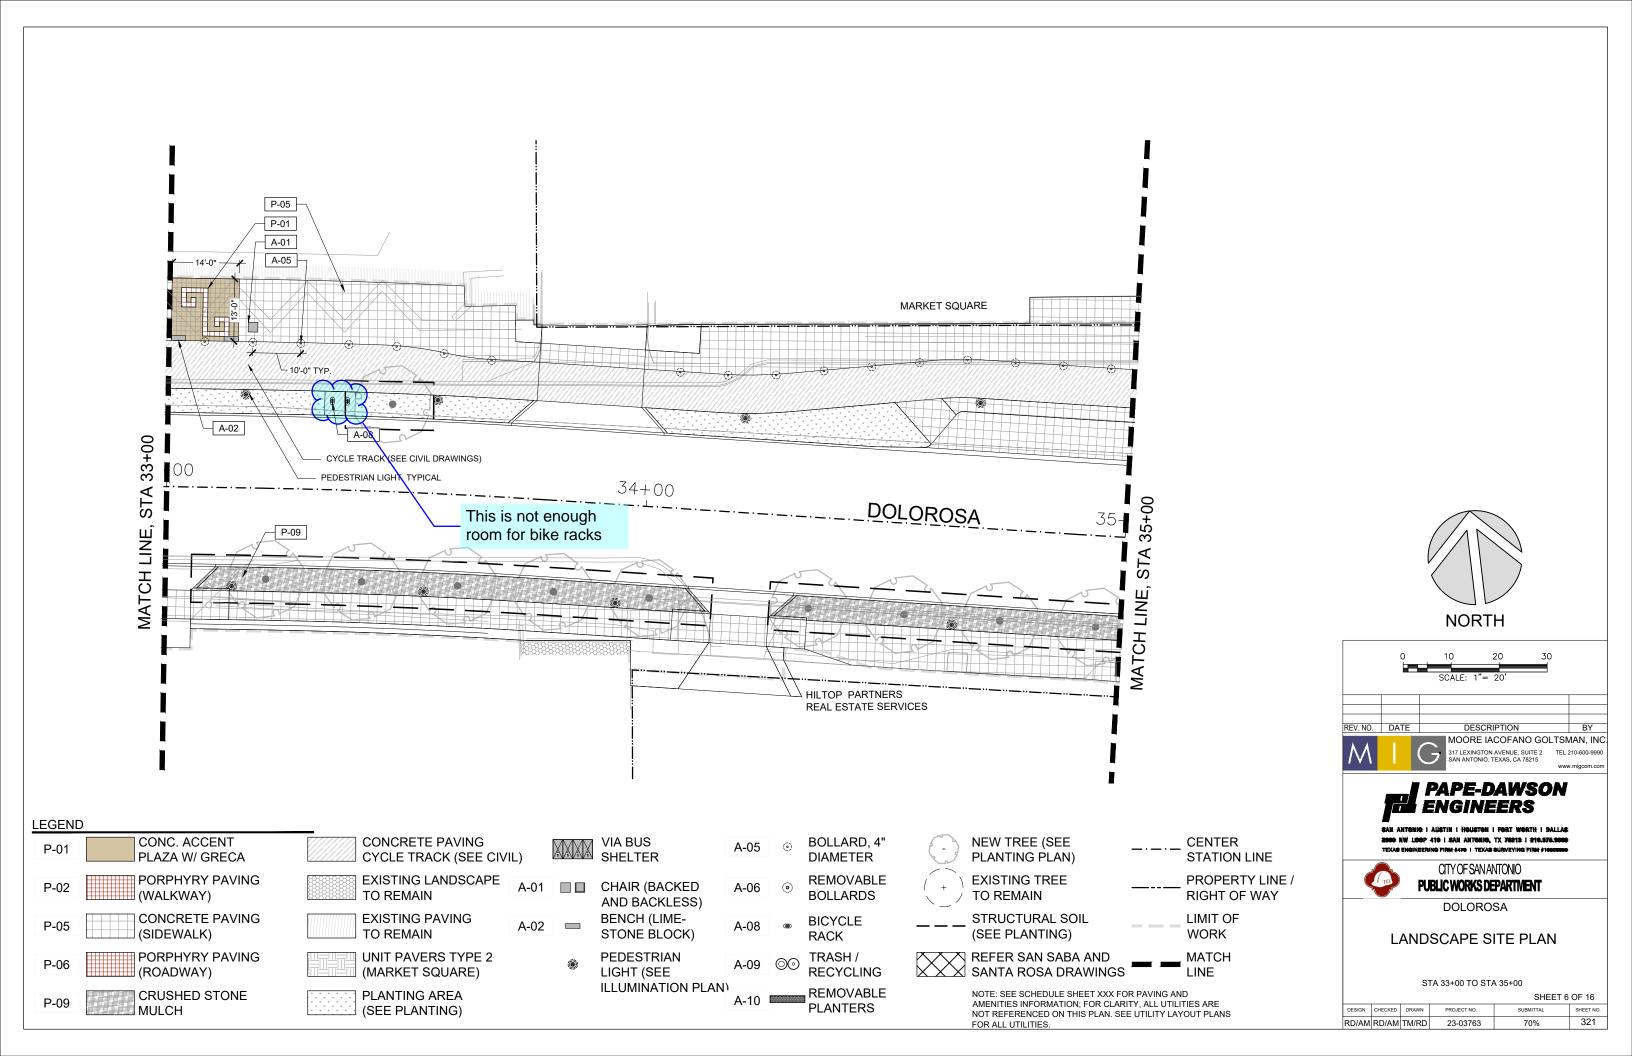


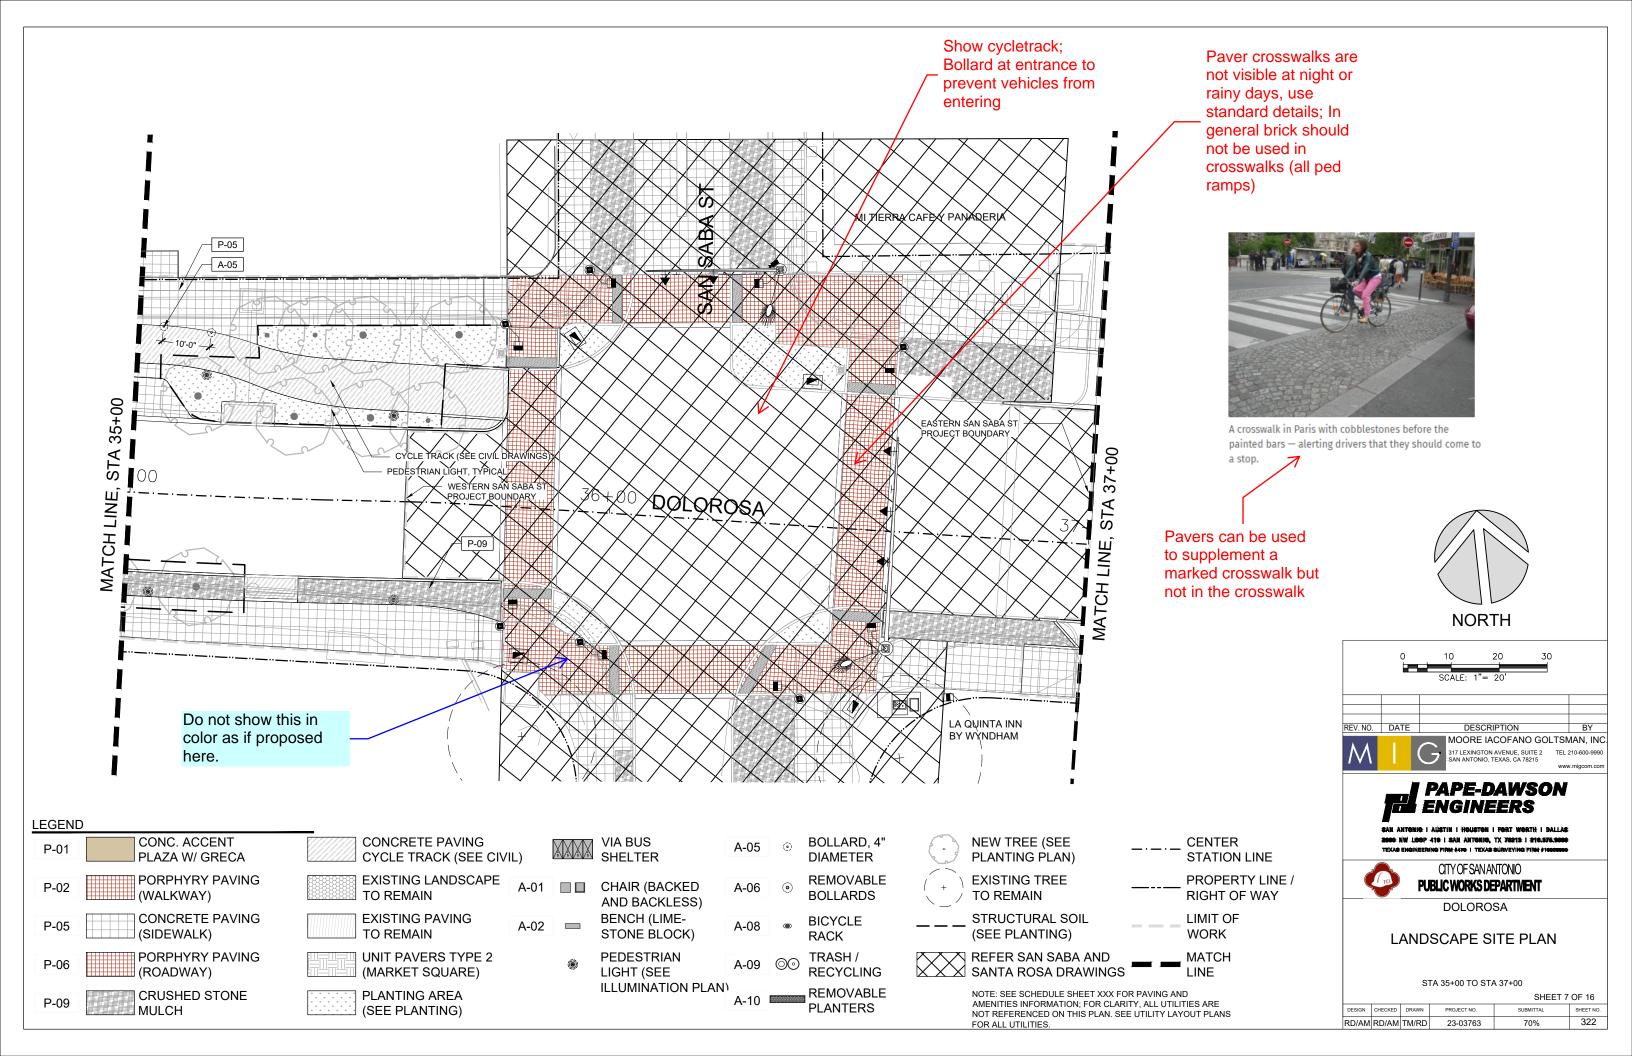

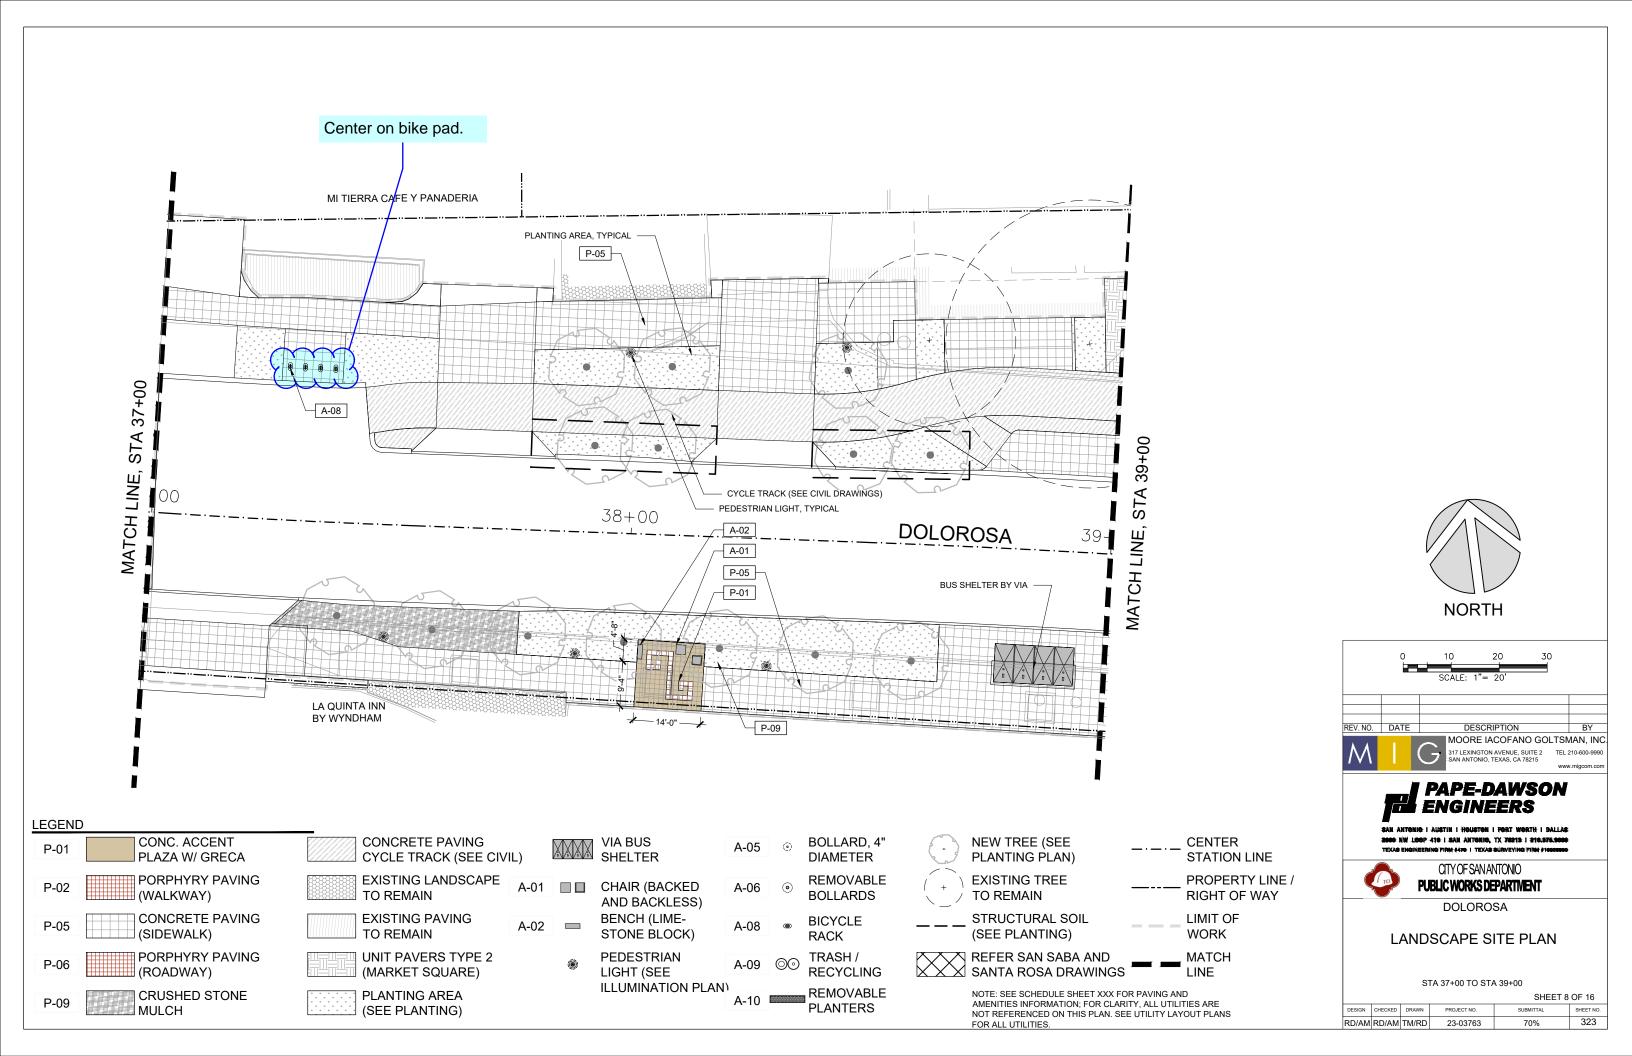

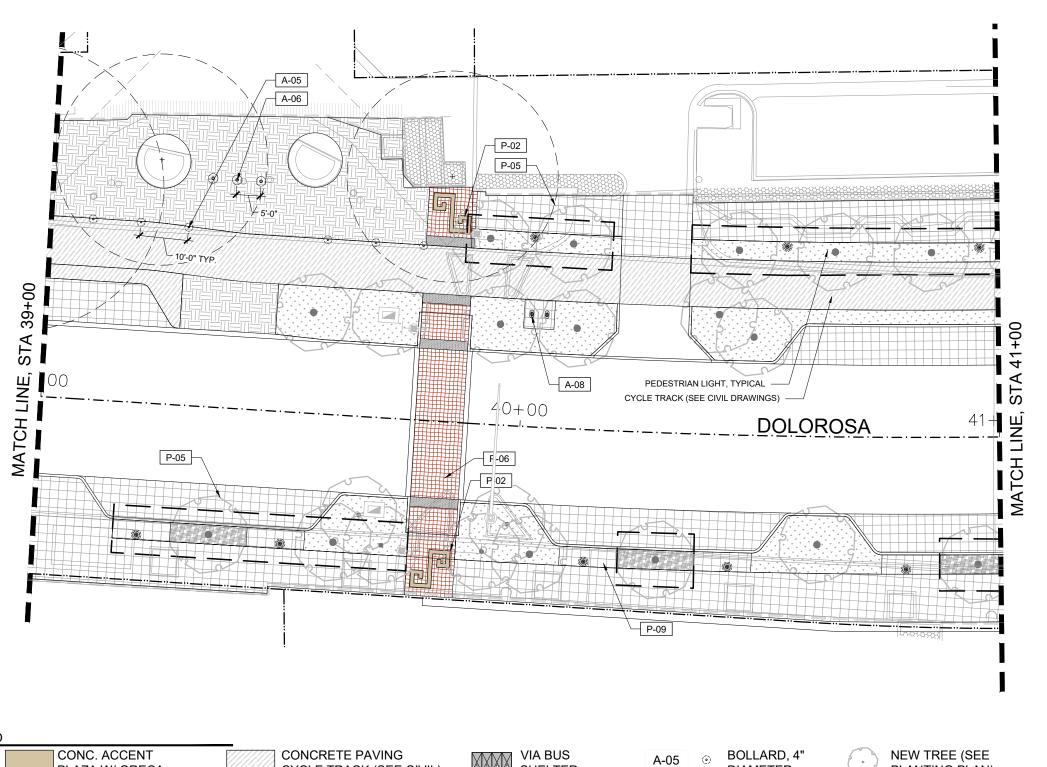



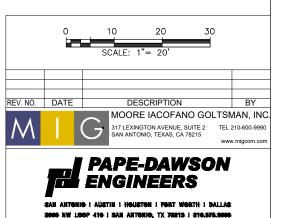




DOLOROSA

LANDSCAPE SITE PLAN

STA 39+00 TO STA 41+00

SHEET 9 OF 16						
DESIGN	CHECKED	DRAWN	PROJECT NO.	SUBMITTAL	SHEET NO.	
RD/AM	RD/AM	TM/RD	23-03763	70%	324	

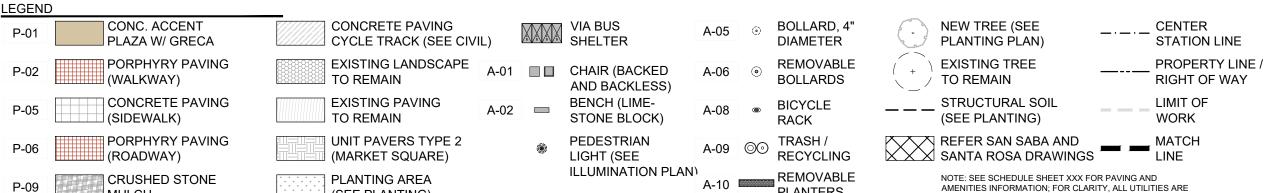



MULCH


(SEE PLANTING)


PLANTERS


NOT REFERENCED ON THIS PLAN. SEE UTILITY LAYOUT PLANS

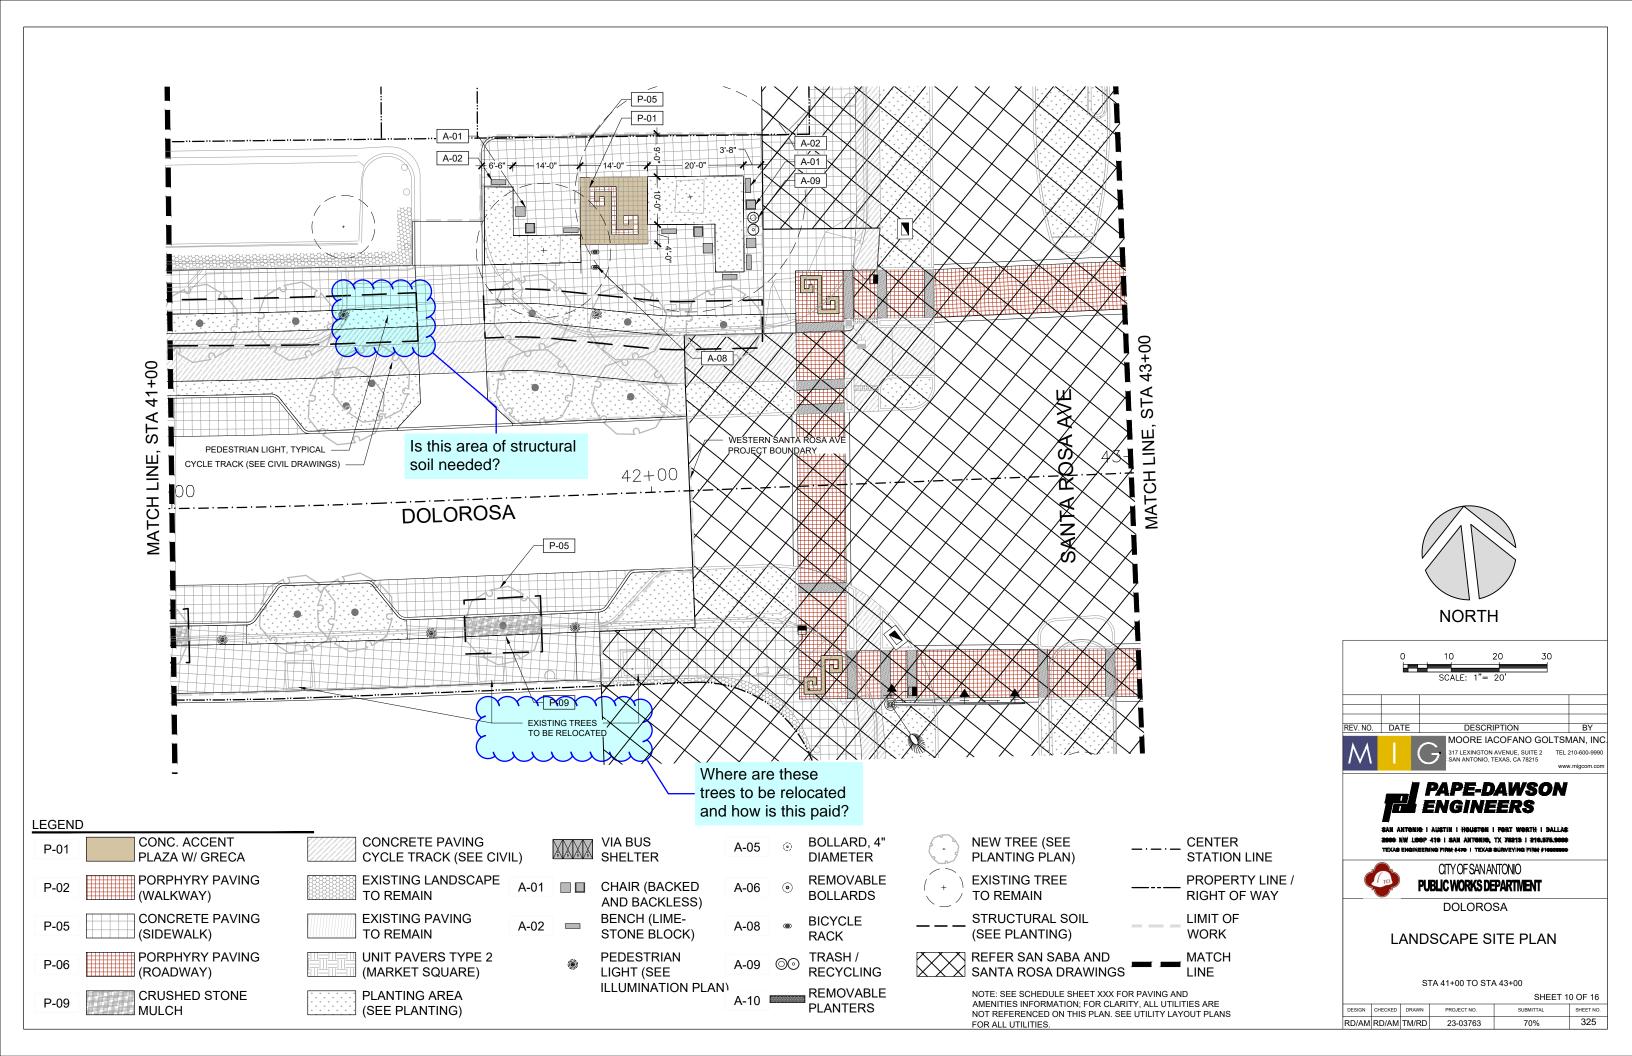


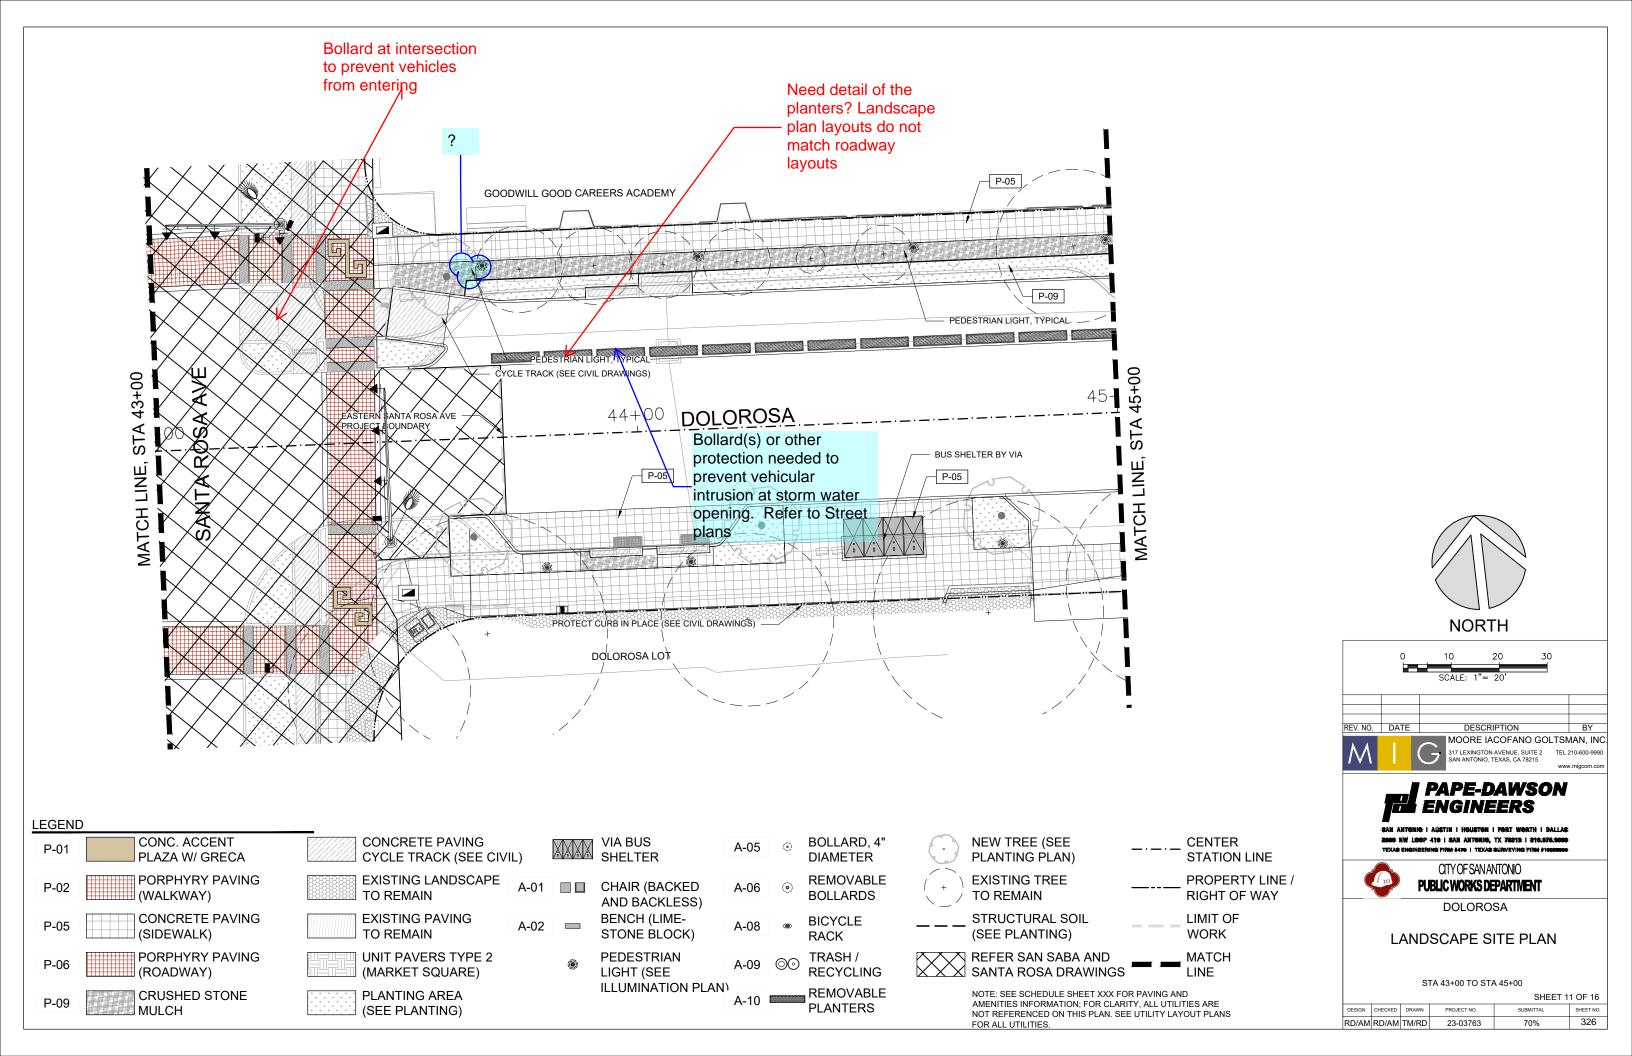


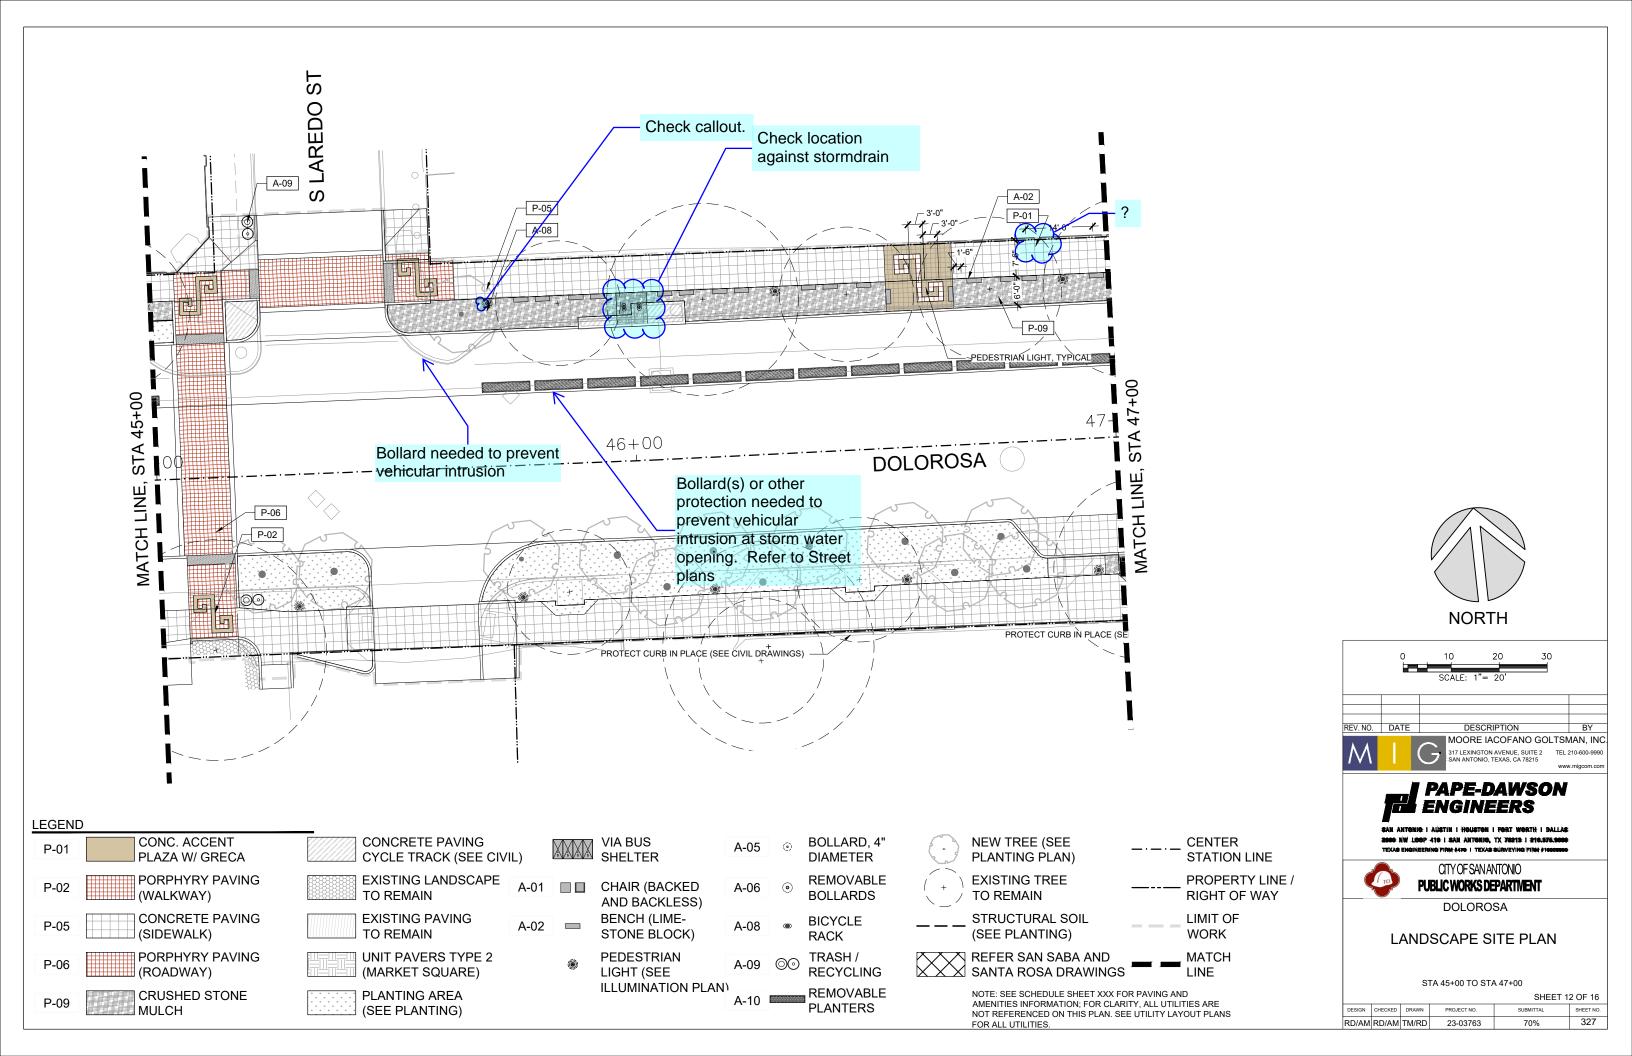

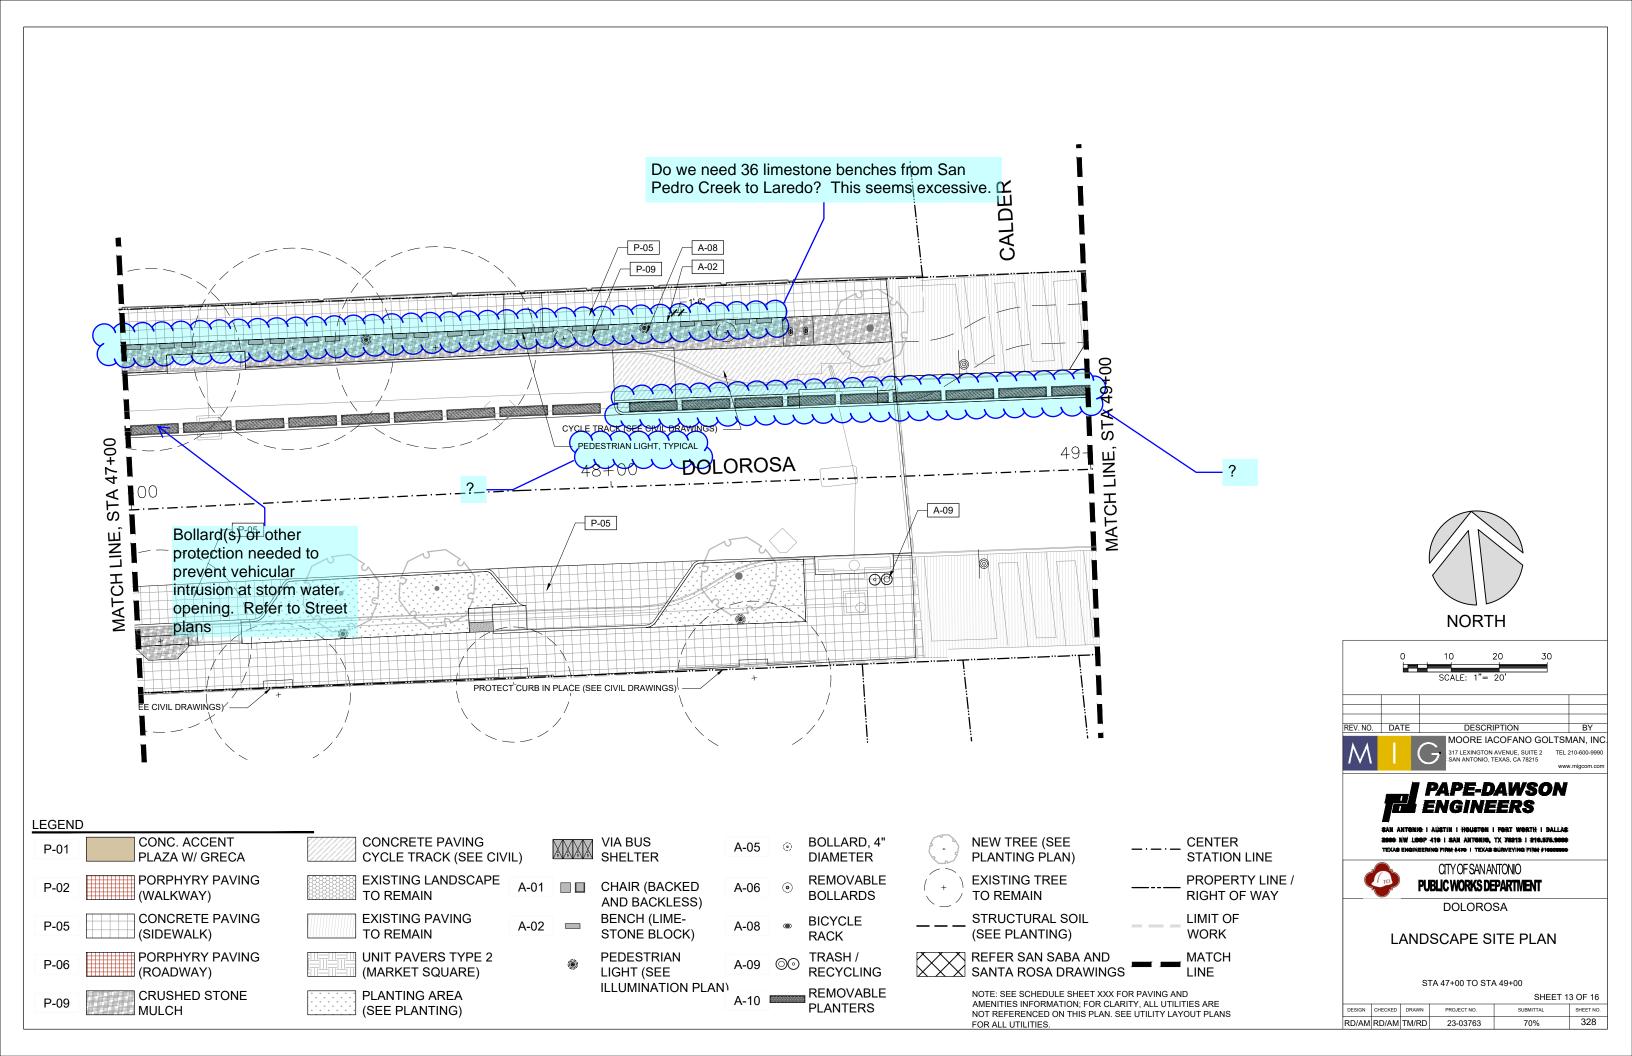

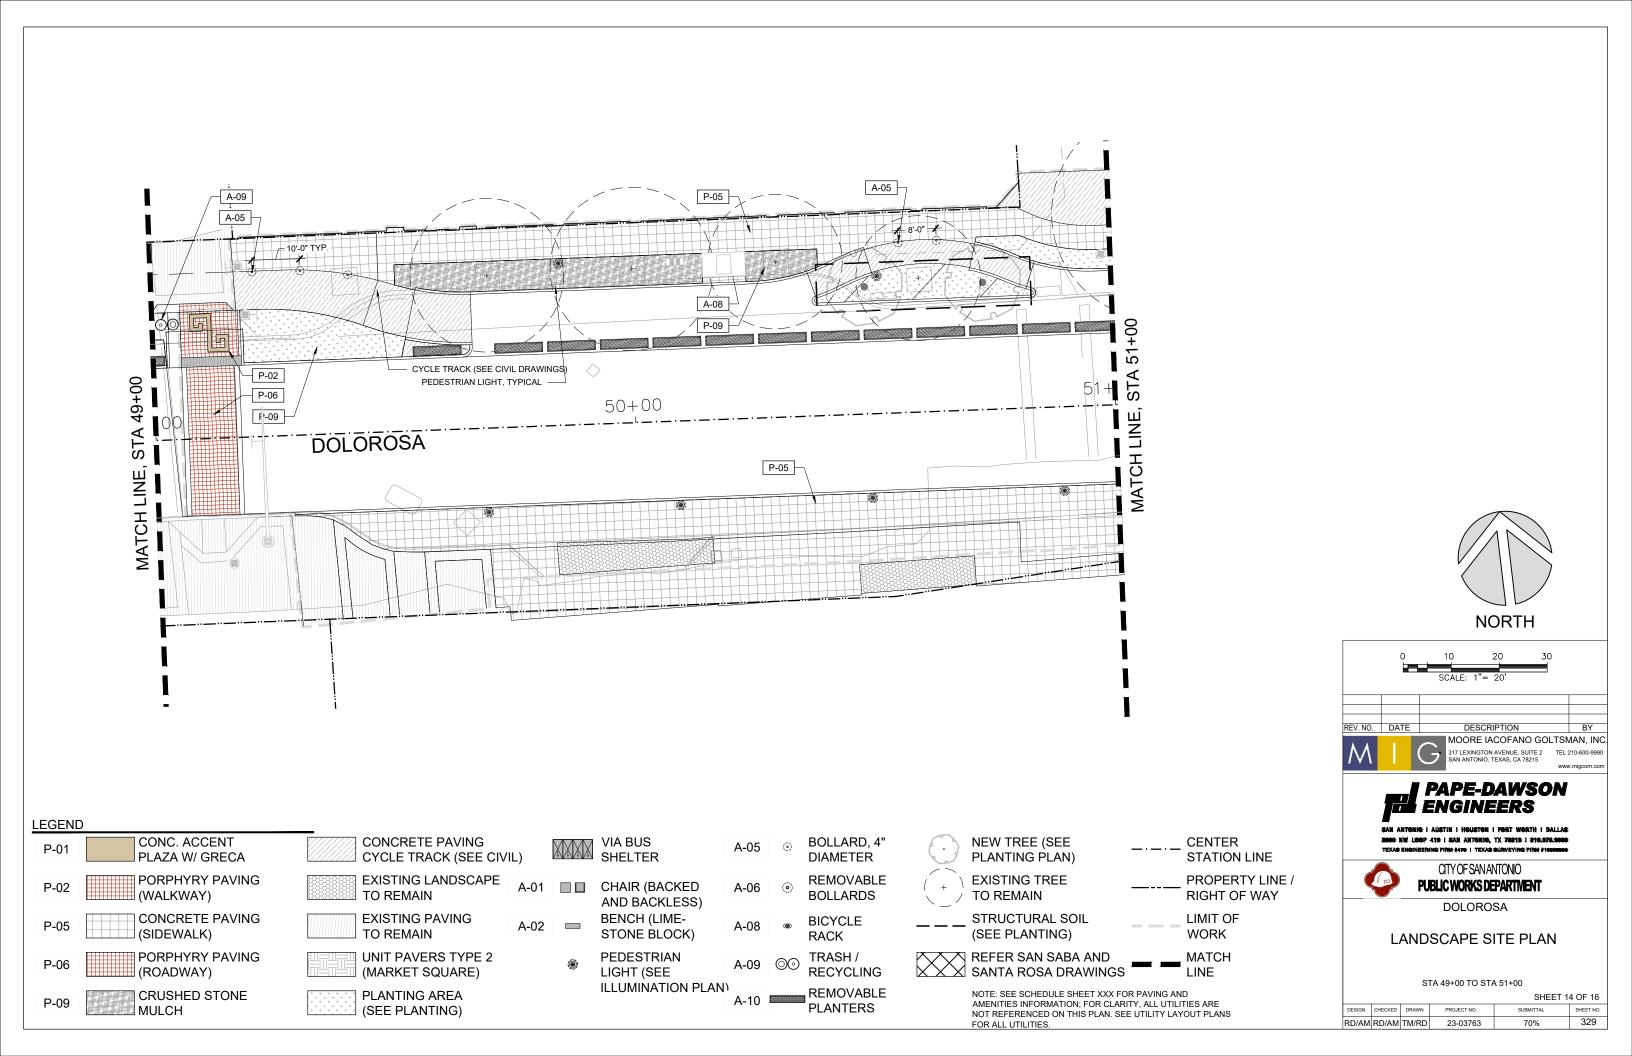

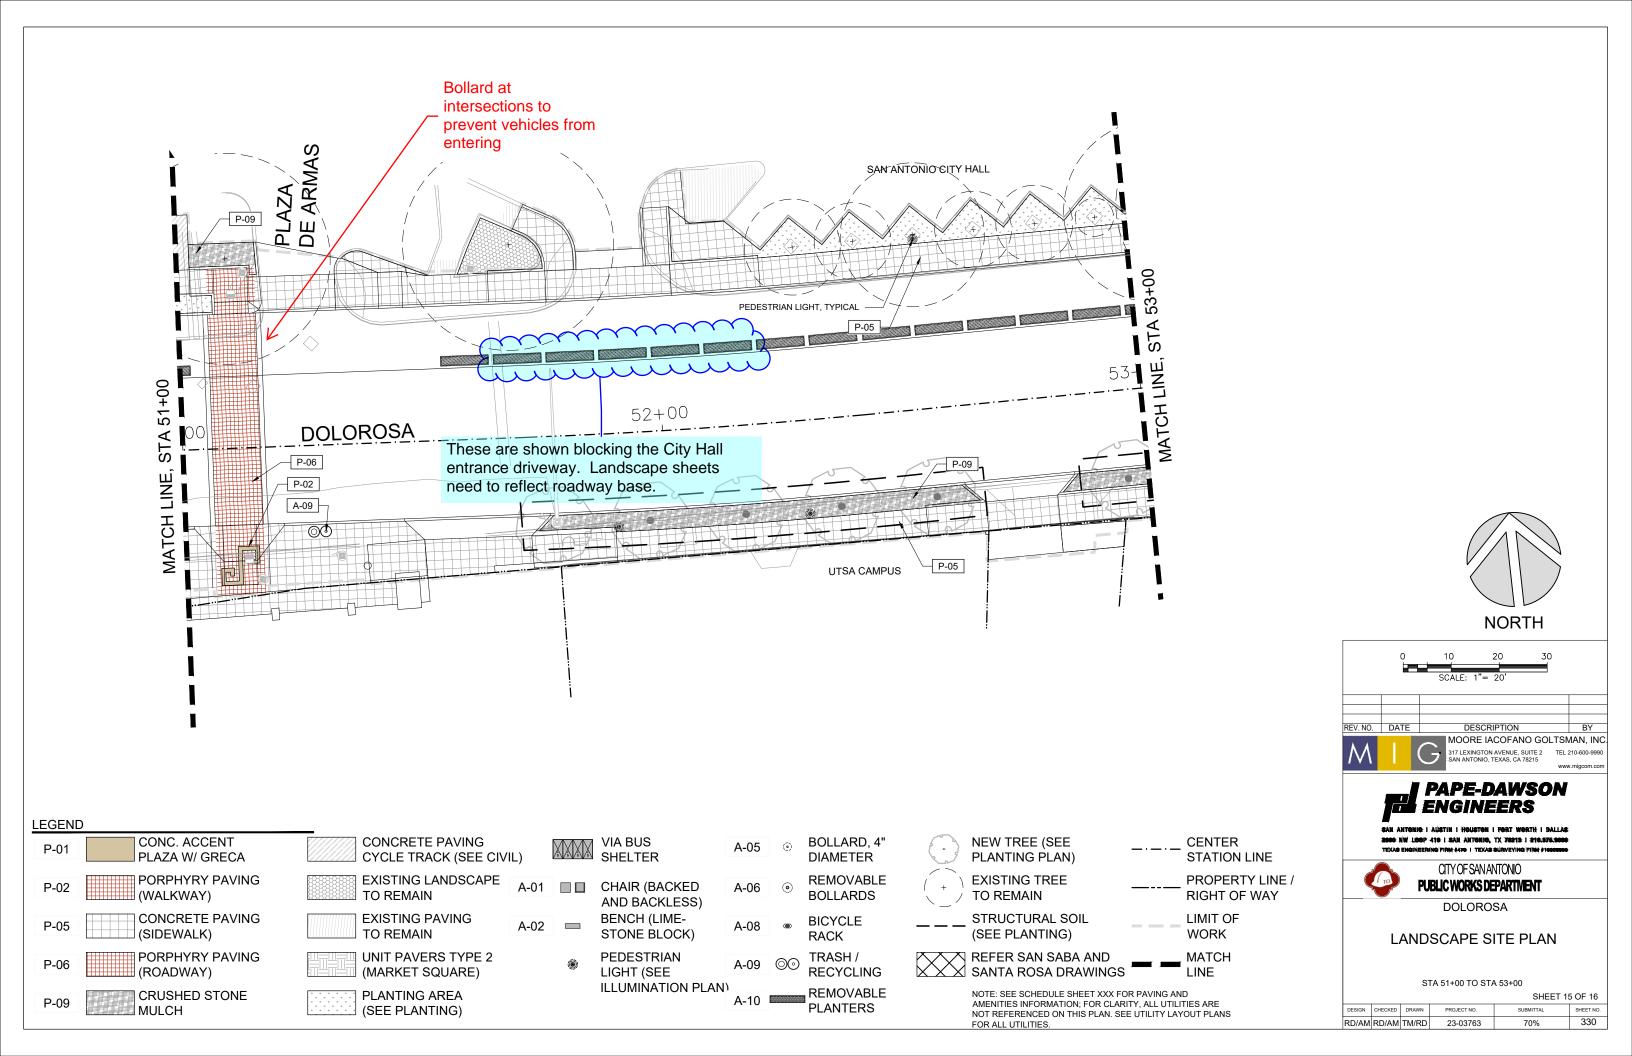

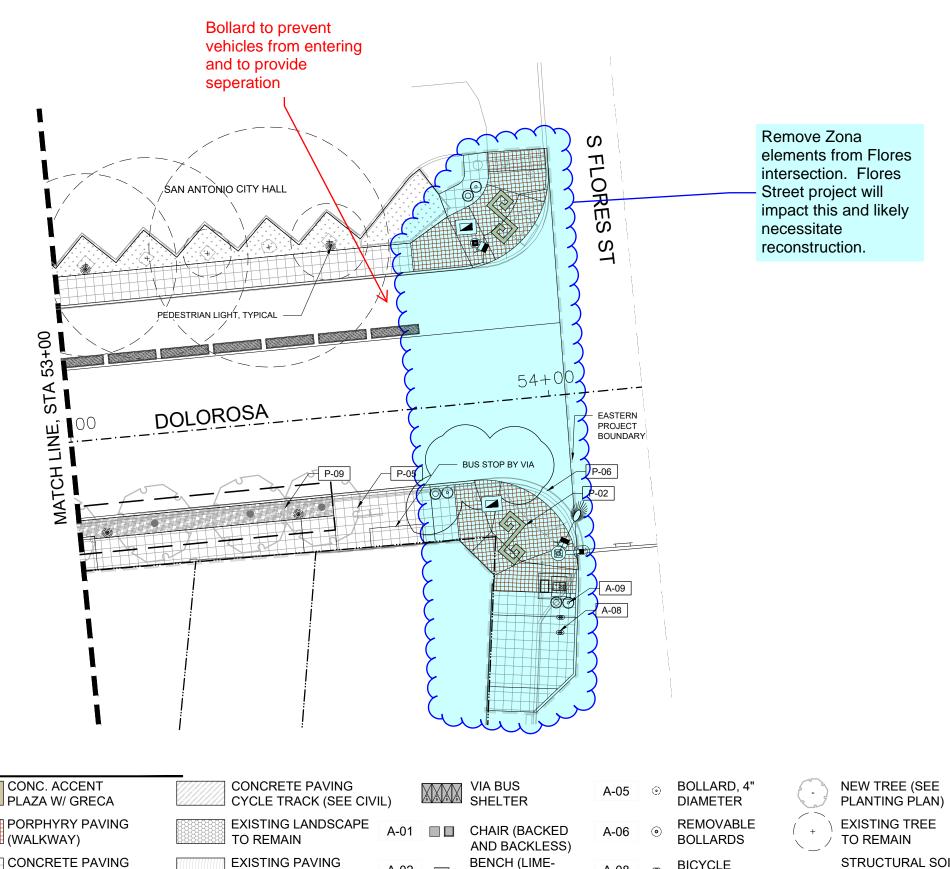

A-02

TO REMAIN

UNIT PAVERS TYPE 2

(MARKET SQUARE)

PLANTING AREA

(SEE PLANTING)

A-08

A-09 ⊚⊙

RACK

STONE BLOCK)

ILLUMINATION PLAN

**PEDESTRIAN** 

LIGHT (SEE

LEGEND

P-01

P-02

P-05

P-06

P-09

(SIDEWALK)


(ROADWAY)

MULCH

PORPHYRY PAVING

CRUSHED STONE



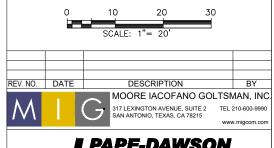

**PAPE-DAWSON ENGINEERS** 

2000 NW LOOP 418 | SAN ANTONIO, TX 78213 | 216.575.0000




CITYOFSANANTONIO PUBLIC WORKS DEPARTMENT


**DOLOROSA** 


LANDSCAPE SITE PLAN

STA 53+00 TO STA 55+00

SHEET 16 OF 16 PROJECT NO. 331 RD/AM RD/AM TM/RD 23-03763

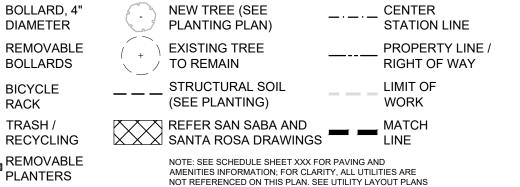

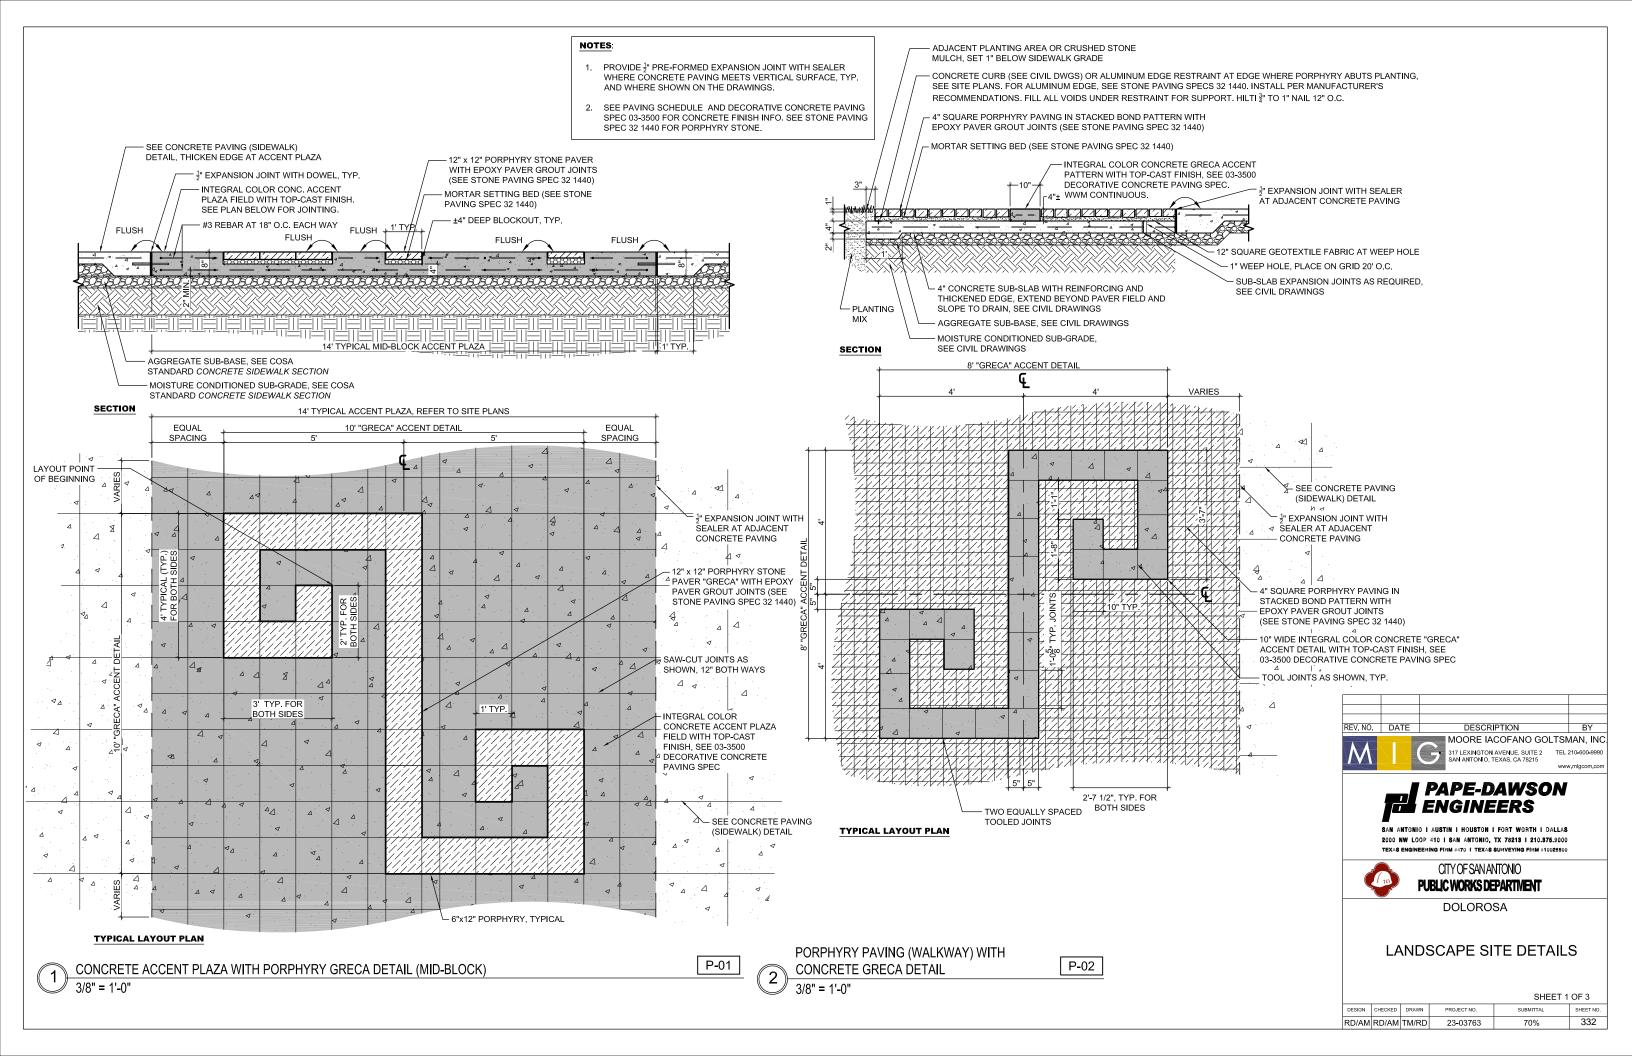


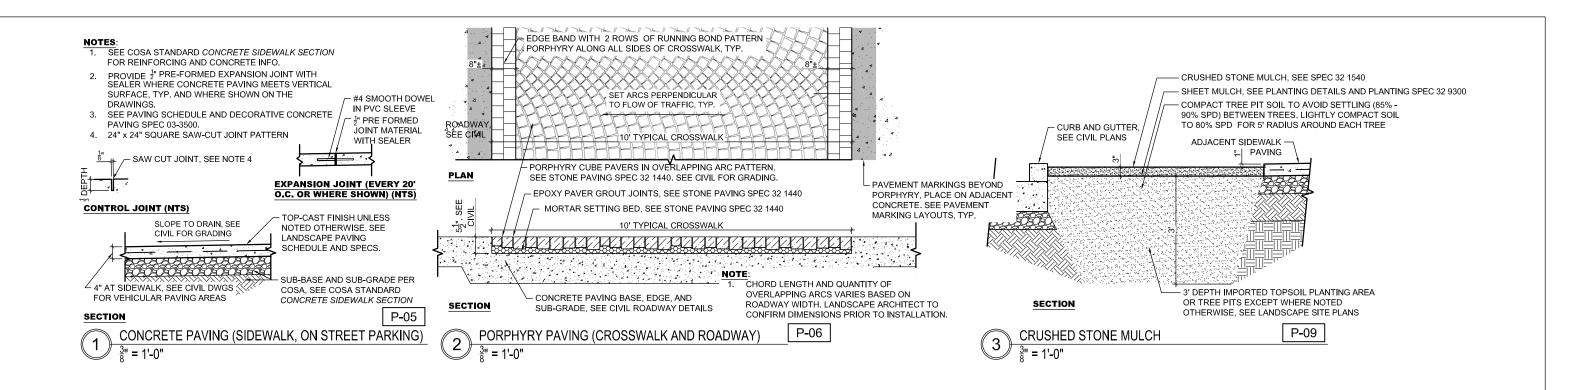

Add detail for Unit Pavers at Market Square

Need detail of the planters



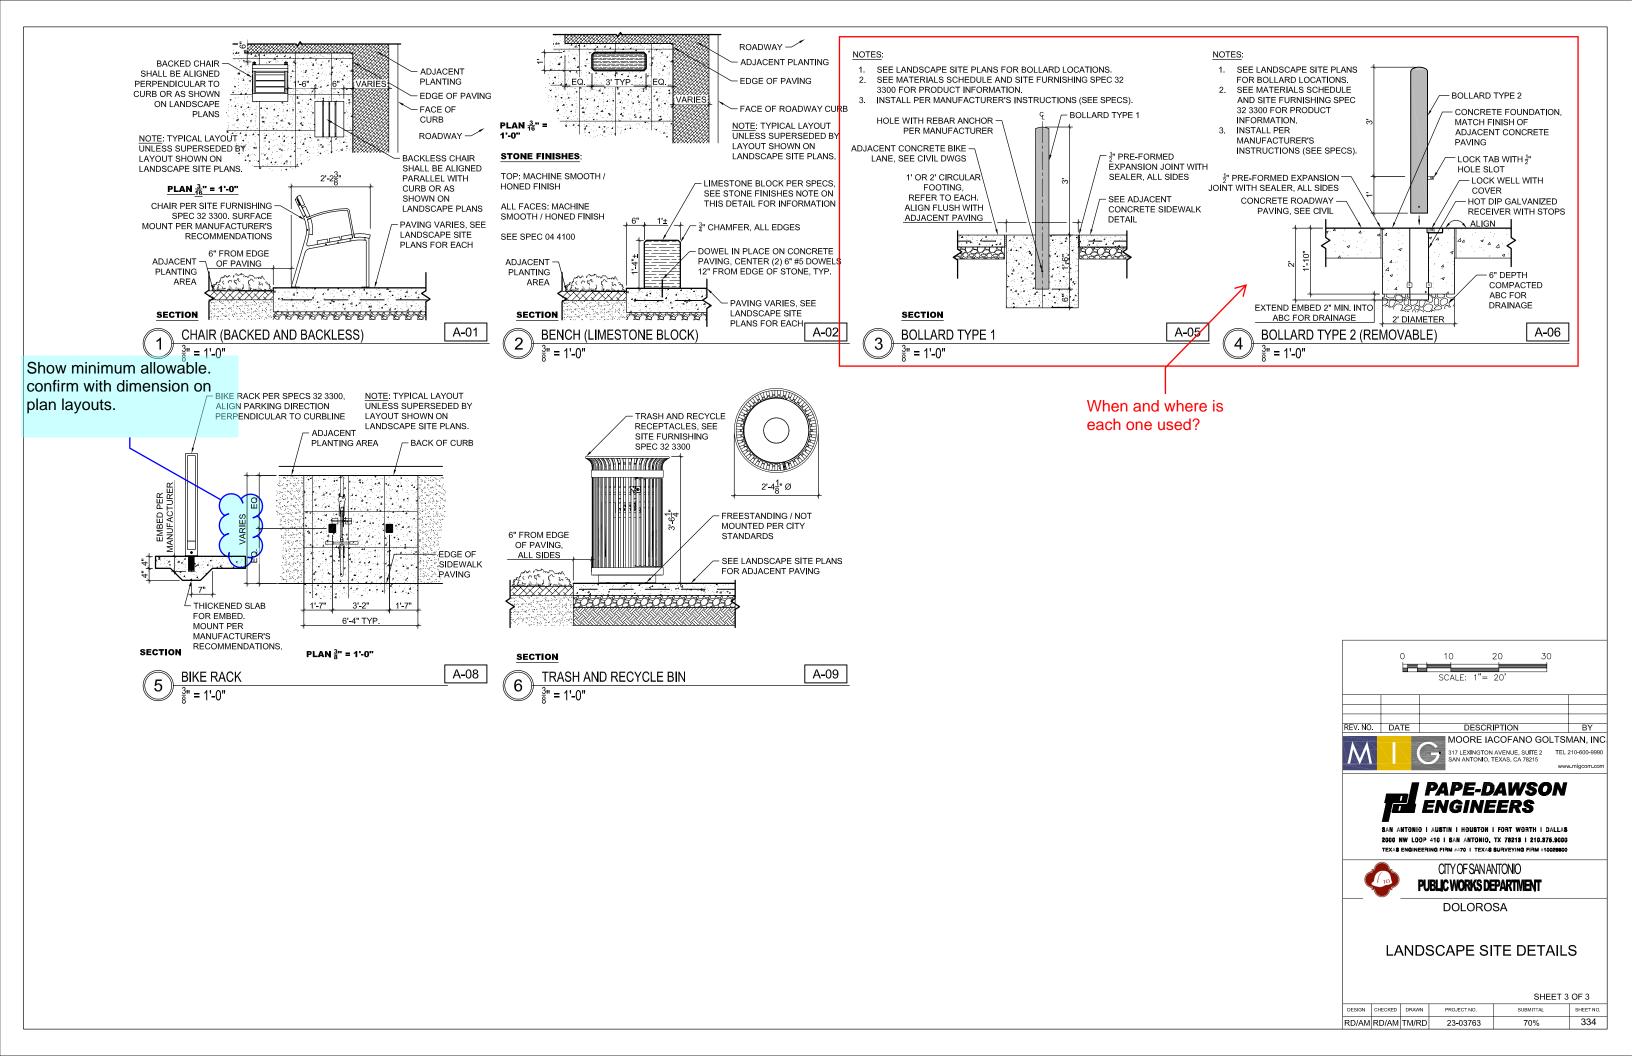

# LANDSCAPE IRRIGATION LEGEND

	MFG'R	MODEL NO.							
SYMBOL	(OR E	L EQUAL)	DESCRIPTION			REM	ARKS		DETAIL
(M)	SUPERIOR CONTROLS	3200	MASTER VALVE	SIZE	PER PLAN,	NORMALLY CLOS	ED MASTER CONT	ROL VALVE	5/ XXX
	MATCO	503 SERIES	MAINLINE ISOLATION GATE VALVES (3-INCH AND SMALLER)	MAIN	I LINE SIZE.	REFER TO PLANS	FOR APPROXIMAT	E LOCATIONS	4-5/ XXX 1/ XXX
•	HUNTER	ICV-###G	REMOTE CONTROL VALVE	SIZE	PER PLAN.				4-5/ XXX 5/ XXX
•	HUNTER	SEE REMARKS	DRIP REMOTE CONTROL VALVE ASSEMBLY	SET A MODE GPM;	AT 40 PSI A EL 1CZ-101 ; INSTALL N	AN. INSTALL WITH ND PLASTIC FILTE -LF FOR ZONES W 10DEL ICZ-101 FOF ND LESS THAN 20	R (150 MESH SIZE) TH FLOWS BETWE ZONES WITH FLC	. INSTALL EN 0.5 AND 15	4-5/ XXX 5/ XXX 1/ XXX
<b>⟨X</b> ⟩	RAIN BIRD	44-LRC	BRASS SINGLE-PIECE QUICK COUPLING VALVE	LOCK 2049 44-K	KING BOLT- LOCKING (	TH LOCKING COVE DOWN LID. REFER COVER KEYS, TWO KEYS FOR EVERY	TO SPECS. PROVI (2) SH-2 HOSE SW	DE W/ TWO (2) IVELS, TWO (2)	4-5/ XXX 4/ XXX
	PW PIPE	N/A	PRESSURE MAINLINE PIPE	WIRE	SIZE AS PER PLAN. SCH. 40 PVC PIPE. INSTALL W/ COPPER TRAC WIRE, TAPED TO MAINLINE AT 10-FOOT INTERVALS, ALONG ALL MAINLINE. NOTE: MAINLINE SHOWN IN PAVED AREAS FOR GRAPHICAL CLARITY ONLY.		ALONG ALL	1/ XXX	
	PW PIPE N/A		NON-PRESSURE LATERAL PIPE	SIZE	PER PLAN.	CLASS 200 PVC P	PE.		
	PW PIPE	N/A	IRRIGATION PIPE / CONTROL WIRE SLEEVE	SLEE	EVING CHAP EVE NEXT T -WIRE DEC	JANTITY AS REQUI RT FOR SIZE (SHEE O ALL MAINLINE SI ODER WIRE FROM	ET -). PROVIDE AN LEEVE LOCATIONS	EXTRA 2" S TO ALLOW FOR	2/ XXX
TREE BUBBLER	LEGEND	1							
SYMBOL	MFG'R	MODEL NO.	DESCIPTION	OP.		R	EMARKS		DETAIL
OTMBOL	SYMBOL (OR EQUAL)		DESCRIPTION	PSI	PSI		DEIME		
	HUNTER	RZWS-36-25 -CV/ PCB-25	TREE ROOT WATERING SYSTEMS IN PLANTING BEDS	30	TUBES IN FLEXIBLE APPROXI	25 EACH.INSTALL T I ADDITION TO TWO E TUBING LOCATION MATE. ACTUAL LO DETERMINED TO O	O (2) ON-GRADE BU ONS AND QUANTIT CATIONS AND QUA	JBBLER ON IES ARE ANTITIES SHALL	6-7/ XXX
	CITY GREEN	ROOTRAIN URBAN	TREE PIT IRRIGATION PLUMBED WITH BUBBLER NOZZLE ON THREAD ADAPTER	30	(1) HU (RRURB	TWO (2) RINGS PINTER PCB-50 BUB 1) DIRECTLY ADJA 1) DIRECTLY ADJA 10DEL (RRURB2) A REFE	BLER. USE SINGLE CENT TO ROOTBA	INLET MODEL LL; USE DOUBLE	8/ XXX
SUB-SURFACE IF	RRIGATION SYSTEM	1	I	1	1				
	MFG'R	MODEL NO.							
SYMBOL	(OR E	EQUAL)	DESCRIPTION	REMA	ARKS				DETAIL
A	NETAFIM	TLAVRV	AIR/VACUUM RELIEF VALVE	HYDR		PT; FIELD LOCATE SHOWN ON PLAN IONS.			2/ XXX
(F)	NETAFIM	TLSOV	MANUAL FLUSH COUPLING AND CAP			AN. ATTACH 3-FEE OX AS PER DETAIL		G AND COIL	3/ XXX
1	HUNTER	ECO-INDICATOR	YELLOW POP-UP INDICATOR	INSTA	ALL AT APP	ROXIMATE LOCATI	ONS SHOWN ON P	LAN.	4/ XXX
	NETAFIM	TLHCVXR5-12##	INLINE EMITTER DRIPLINE W/ CUPRON ROOT INTRUSION PROTECTION, ANTI-SIPHON, PRESSURE COMPENSATING, SELF-FLUSHING EMITTERS W/ HIGH CHECK VALVE. USE	OPER	RATING PSI	EMITTER FLOW	MAX ALLOWED HORIZONTAL SPACING	BURIAL DEPTH	5/ XXX 1-3/ XXX
	ATION OVETERA		NETAFIM 17MM INSERT FITTINGS		30	0.56 GPH	12"	3"	
EXISTING IRRIGA		PIRTION	DEMADI/S						DETAIL
SYMBOL	DESCI	RIPTION	REMARKS						DETAIL
	EXISTING	IRRIGATION	CONTRACTOR SHALL ADJUST (E) IRRIGA' REQUIRED TO MAINTAIN AND PROVIDE H PROJECT'S LIMIT OF WORK.						N/A

CVMPOL	MFG'R	MODEL NO.	DECO	DIDTION		DEMARKO	DETAIL		
SYMBOL	(OR E	QUAL)	DESCI	DESCRIPTION		REMARKS			
WM	N/A	N/A	WATE (WM)	R METER		RS, REFER TO CIVIL DWGS. SIZE PER PLAN. VERIFY STATIC RESSURE IN FIELD PRIOR TO CONSTRUCTION.	PER CIVIL DWGS.		
	N/A	N/A	DOUB (DCVA	LE CHECK VALVE ASSEMBLY	INSTALL I	BELOW GRADE WITHIN VAULT. SIZE PER PLAN.	2/ XXX		
CONTROLLER SO	CHEDULE								
SYMBOL	MFG'R	MODEL NO.		DESCRIPTION		REMARKS	DETAIL		
(A) (B) (C) (D)	HUNTER	A2C-75D-M		AUTOMATIC IRRIGATION CONTROL	LER 'A'	75-STATION, TWO-WIRE CONTROLLER IN METAL CABINET. MOUNT CONTROLLER WITHIN STRONGBOX PEDESTAL ENCLOSURE MODEL # SB-18SS. PROVIDE WITH HUNTER WIRELESS SOLAR SYNC ASSEMBLY (SENSOR AND RECEIVER). INSTALL RECEIVER ON ONE SIDE OF ENCLOSURE WITH HUNTER WR-GUARD. SOLAR SYNC SHALL BE INSTALLED AT FINAL LOCATION AS DIRECTED BY OWNER AND LANDSCAPE ARCHITECT.	3/ XXX		
Ś	HUNTER	WWS-SEN		WIRELESS SOLAR SYNC SENSOR, RECEIVER, AND MOUNT		ONE PER CONTROLLER.	PER MFG'R		
F	HUNTER	HFS-FCT-100	)	IMPELLER-TYPE FLOW SENSOR WI SENSOR RECEPTACLE TEE	тн	1" SIZE. WIRE DIRECTLY TO TWO-WIRE DECODER CABLE USING SENSOR DECODER (ICD-SEN). 2 GALLON PER MINUTE FLOW REQUIRED TO REGISTER FLOW.	5/ XXX 3/ XXX		
NOT SHOWN	HUNTER	ID2GRY		TWO-WIRE DECODER CABLE		12 AWG SOLID-CORE TWISTED PAIR, POLYETHYLENE COATED DOUBLE JACKETED (GRAY) CABLE. SPLICES WHEN APPROVED SHALL BE WATERTIGHT ELECTRICAL WIRE CONNECTORS 3M MODEL # DBRY-6	2/ XXX		
NOT SHOWN	HUNTER	1CD-100		TWO-WIRE DECODERS		SINGLE-STATION DECODER WITH SURGE SUPPRESSION AND GROUND WIRE.	4/ XXX		

GENERAL LEGEND


SLEEVING: INSTALL IN LOCATIONS AS SHOWN ON PLAN.
REFER TO PIPE/WIRE SLEEVING CHART ON THIS SHEET FOR SIZE AND TYPE.

(#) M = MAINLINE SLEEVE

(#) L = LATERAL SLEEVE

(#) W = WIRING CONDUIT

VALVE CALL OUT

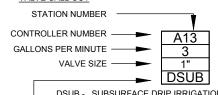


DSUB - SUBSURFACE DRIP IRRIGATION
TBUB - ROOT WATERING TREE BUBBLER - TRNG - ROOT WATER TREE RING

LIMIT OF WORK

### STATEMENT OF IRRIGATION DESIGN STANDARDS CONFORMITY

THESE PLANS IS COMPLETE AND CONFORMS TO THE DESIGN AND INSTALLATION PARAMETERS OF THE IRRIGATION DESIGN AND EQUIPMENT STANDARDS SET OUT IN 35-510(j) AND 35-511(C)(6) OF THE CITY OF SAN ANTONIO UNIFIED DÉVÉLOPMENT CODE.

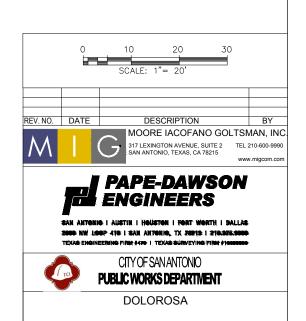

IRRIGATION LEGEND

SHEET 1 OF 1 DESIGN CHECKED DRAWN PROJECT NO. 335 RD/AM RD/AM TM/RD 23-03763 70%

# GENERAL LANDSCAPE IRRIGATION NOTES


- 1. THE IRRIGATION SYSTEM DESIGN FOR POINT-OF-CONNECTION (POC) IS BASED ON A MINIMUM EXISTING AVERAGE STATIC PRESSURE OF AT THE MUNICIPAL SERVICE LINE AND A MAXIMUM DEMAND AS NOTED ON THE PLANS. THE CONTRACTOR SHALL PROVIDE A STATIC PRESSURE TEST AT POC FOR APPROVAL BY CITY OF SAN ANTONIO'S REPRESENTATIVE PRIOR TO ORDERING MATERIALS AND PRIOR TO CONSTRUCTION. CONTRACTOR SHALL REPORT ANY DIFFERENCE BETWEEN THE WATER PRESSURE INDICATED ON THE DRAWINGS AND THE ACTUAL PRESSURE READING AT THE IRRIGATION POINT OF CONNECTIONS TO THE CITY OF SAN ANTONIO'S REPRESENTATIVE. IN THE EVENT PRESSURE DIFFERENCES ARE NOT REPORTED PRIOR TO THE START OF CONSTRUCTION, THE CONTRACTOR SHALL ASSUME FULL RESPONSIBILITY FOR ANY REVISIONS NECESSARY.
- 2. THESE DRAWINGS ARE DIAGRAMMATIC. DRAWINGS DO NOT SHOW ALL OFFSETS AND FITTINGS REQUIRED FOR A COMPLETE SYSTEM. IRRIGATION COMPONENTS SHOWN WITHIN PAVED AREAS FOR GRAPHIC CLARITY ONLY. PLACE ALL PIPING, VALVES, QUICK COUPLING VALVES, AND OTHER IRRIGATION COMPONENTS WITHIN ADJACENT PLANTING AREAS EXCEPT WHERE PIPES CROSS PAVING. AVOID ANY CONFLICTS BETWEEN THE IRRIGATION SYSTEM, TREES, PLANTING, SITE FEATURES AND UTILITIES INCLUDING STORM DRAINAGE. ALL DIMENSIONS, QUANTITIES AND MATERIALS SHALL BE VERIFIED BY THE CONTRACTOR PRIOR TO THE START OF CONSTRUCTION.
- 3. DO NOT INSTALL THE IRRIGATION SYSTEM AS SHOWN ON THE DRAWINGS WHEN IT IS OBVIOUS IN THE FIELD THAT OBSTRUCTIONS, GRADE DIFFERENCES OR DIFFERENCES IN THE AREA DIMENSIONS EXIST. SUCH OBSTRUCTIONS OR DIFFERENCES SHOULD BE BROUGHT TO THE ATTENTION OF THE CITY OF SAN ANTONIO'S REPRESENTATIVE. IN THE EVENT NOTIFICATION IS NOT PERFORMED, THE CONTRACTOR SHALL ASSUME FULL RESPONSIBILITY FOR ANY REVISIONS NECESSARY
- 4. INSTALLATION OF THE IRRIGATION SYSTEM UNDER THIS CONTRACT SHALL CONFORM TO ALL LOCAL, COUNTY, AND STATE PROVISIONS, INCLUDING THOSE STATED IN THE LATEST EDITION OF THE UNIFORM PLUMBING CODE, AND THE NATIONAL ELECTRIC CODE. IN THE EVENT OF DIFFERENCES BETWEEN THE CODE COMPLIANCE REQUIREMENTS OF THIS CONTRACT, THE BETTER QUALITY, HIGHER STANDARD, LARGER SIZE, AND MORE STRINGENT REQUIREMENT SHALL PREVAIL.
- 5. IT IS THE RESPONSIBILITY OF THE CONTRACTOR TO FAMILIARIZE HIM/HERSELF WITH ALL GRADE DIFFERENCES, LOCATION OF WALLS, ETC. CONTRACTOR SHALL COORDINATE HIS/HER WORK WITH THE GENERAL CONTRACTOR AND OTHER SUB-CONTRACTORS FOR THE LOCATION AND INSTALLATION OF PIPE SLEEVES AND CONDUITS WHERE SHOWN ON PLANS AND AS REQUIRED PRIOR TO THE PLACEMENT OF PAVING. COORDINATE WITH OTHER WORK. SLEEVES AND CONDUITS SHALL BE SIZED TO ALLOW A MINIMUM OF 25% VOID SPACE.
- 6. PRIOR TO ANY TRENCHING THE CONTRACTOR SHALL ASCERTAIN THE LOCATION OF ALL NEW AND EXISTING UNDERGROUND UTILITY LINES. CALL 811 A MINIMUM OF FORTY-EIGHT (48) HOURS PRIOR TO THE START OF CONSTRUCTION.
- 7. THE INTENT OF THIS IRRIGATION SYSTEM IS TO PROVIDE THE MINIMUM AMOUNT OF WATER TO MAINTAIN GOOD PLANT HEALTH, APPEARANCE AND REASONABLE GROWTH. THE AMOUNT OF SUPPLEMENTAL WATER A PLANT REQUIRES IS DEPENDENT ON SOIL TYPE, PLANT MATERIAL, ROOTING DEPTH, CLIMATE, SEASONAL CHANGES, SLOPES, MOUNDS, SUN, SHADE AND WIND. IT IS THE RESPONSIBILITY OF THE CONTRACTOR TO ADJUST THE IRRIGATION SCHEDULE AND ET VARIABLES AS NEEDED. IN ADDITION, THE CONTRACTOR SHALL PROVIDE SUPPLEMENTAL WATER TO ACCOMMODATE SPECIAL WATERING NEEDS OF PLANT MATERIAL THROUGH THE MAINTENANCE PERIOD. ACTUAL STATION RUN TIMES MAY VARY IN ACCORDANCE WITH VARYING SITE CONDITIONS.
- 8. CONTRACTOR SHALL ADJUST THE PLACEMENT OF THE DRIPLINE LAYOUT AS PER ACTUAL FIELD CONDITIONS TO ACHIEVE FULL COVERAGE OF ALL PLANTED AREAS. THE CONTRACTOR WILL BE RESPONSIBLE OF INSTALLING ADDITIONAL DRIPLINE, AS NEEDED, TO PROVIDE ADEQUATE COVERAGE, AT NO ADDITIONAL COST TO THE CITY OF SAN ANTONIO. REFER TO IRRIGATION EQUIPMENT LEGEND FOR MAXIMUM ALLOWED VERTICAL DRIPLINE SPACING.
- 9. IRRIGATION SYSTEM SHALL BE OPERATIONAL & COVERAGE APPROVED BY THE CITY OF SAN ANTONIO'S REPRESENTATIVE PRIOR TO INSTALLATION OF PLANTING MATERIAL.

- 10. THE CONTRACTOR SHALL FLUSH ALL EMISSION EQUIPMENT FOR OPTIMUM PERFORMANCE TO PROVIDE OPTIMAL EVEN DISTRIBUTION OF WATER, AND TO PROVIDE PROPER COVERAGE.
- 11. DRAINAGE OF IRRIGATION WATER THROUGH DRIP EMITTERS OR BUBBLERS WILL NOT BE ALLOWED. DURING THE COURSE OF CONSTRUCTION, THE CONTRACTOR SHALL INSTALL ADDITIONAL IN-LINE CHECK VALVES AS REQUIRED IN ANY AREA WHERE EMISSION DEVICES SHOW SIGNS OF DRAINAGE AFTER IRRIGATION SYSTEM HAS OPERATED FROM AN ON TO OFF POSITION. INSTALLATION OF ADDITIONAL IN-LINE CHECK VALVES SHALL BE INCLUDED IN THE BID PRICE WITHOUT ADDITIONAL COST TO THE CITY OF SAN ANTONIO.
- 12. MAINLINE PIPE SIZE DOWNSTREAM OF LAST PIPE SIZE CALL OUT TO BE SAME SIZE AS INLET OF PRODUCT IT SUPPLIES (BUT NOT LESS THAN 1-INCH). LATERAL PIPE SIZES DOWNSTREAM OF LAST PIPE SIZE CALL OUT TO BE SAME AS LAST PIPE SIZE CALLED OUT (BUT NOT LESS THAN 3/4-INCH).
- 13. SUBSURFACE EMITTER FLOW RATE, EMITTER SPACING AND LATERAL SPACING IS BASED ON TYPICAL SOILS ENCOUNTERED IN THE AREA. THE CONTRACTOR SHALL MAKE ANY MODIFICATION TO EMITTER FLOW RATE, EMITTER SPACING, AND LATERAL SPACING AS REQUIRED TO COMPLY WITH MANUFACTURER'S RECOMMENDATIONS FOR AN EVEN WETTED PATTERN, BASED ON ACTUAL SOIL ANALYSIS. REFER TO DRIPLINE MANUFACTURER RECOMMENDATIONS FOR ADDITIONAL INFORMATION. FINAL EMITTER SPACING AND FLOW RATE TO BE APPROVED BY THE CITY OF SAN ANTONIO'S REPRESENTATIVE.
- 14. CONTRACTOR SHALL ADJUST THE DRIPLINE LAYOUT, WHEN PLANTER SLOPE IS GREATER THAN 5 PERCENT, TO PROVIDE LATERAL ROW SPACING THAT IS 25 PERCENT GREATER WITHIN THE BOTTOM ONE-THRID OF THE SLOPE.
- 15. LOCATIONS AND THE QUANTITIES OF FLUSH VALVES AND AIR/VACUUM RELIEF VALVES (AVRV) SHOWN ON PLANS ARE APPROXIMATE. CONTRACTOR IS RESPONSIBLE FOR VERIFYING HIGHEST POINTS OF EACH HYDROZONE AND LOCATING AVRV'S AS REQUIRED AND FOR INSTALLING ADDITIONAL FLUSH VALVES, AS NEEDED, ACCORDING TO MANUFACTURER'S GALLONS PER HOUR REQUIREMENTS PER HYDROZONE AT NO ADDITIONAL COST TO THE CITY OF SAN ANTONIO.
- 16. ALL VALVES PROVIDING IRRIGATION TO SLOPES AREAS SHALL BE SCHEDULED IN MULTIPLE. SHORT CYCLES TO HELP ELIMINATE IRRIGATION WATER RUNOFF.
- 17. IT IS THE RESPONSIBILITY OF THE CONTRACTOR TO VERIFY AND COORDINATE AND PROVIDE THE FINAL CONNECTION OF THE CONTROLLERS AND BOOSTER PUMPS TO ITS DEDICATED POWER SOURCE. ALL ELECTRICAL WORK SHALL BE PERFORMED BY A LICENSED ELECTRICAL CONTRACTOR AND SHALL CONFORM TO THE LATEST EDITION OF THE N.E.C. AND ALL STATE AND LOCAL CODES AND REGULATIONS.
- 18. IT IS THE RESPONSIBILITY OF THE CONTRACTOR TO PROVIDE AND INSTALL REMOTE CONTROL WIRES FROM VALVES TO CONTROLLERS; PROVIDE AND INSTALL COMMUNICATION WIRES FROM PUMPS TO CONTROLLERS; AND MAKE FINAL CONNECTION OF REMOTE CONTROL WIRES AND COMMUNICATION WIRES AT THE CONTROLLERS. RESPECTIVELY.
- 19. REMOTE CONTROL WIRES SHALL BE PULLED TO FARTHEST POINTS OF THE IRRIGATION MAINLINE. WIRES TO BE LOCATED IN VALVE BOX AND SHALL BE HAVE ENDS CAPPED WITH WATERPROOF WIRE SPLICES.
- 20. ALL IRRIGATION EQUIPMENT SHALL BE AS LISTED OR EQUAL AS APPROVED BY THE CITY OF SAN ANTONIO'S REPRESENTATIVE.
- 21. SEE IRRIGATION DETAILS, TECHNICAL SPECIFICATIONS AND PLANTING PLANS AS PART OF THESE CONSTRUCTION DOCUMENTS.
- 22. ALL TRENCHING SHALL COMPLY WITH TREE PRESERVATION. SEE PLANTING PLANS FOR ADDITIONAL INFORMATION.

# **UTILITY NOTES**

- 1. WHERE IT IS NECESSARY TO EXCAVATE IN AREAS ADJACENT TO UTILITIES, THE CONTRACTOR SHALL POTHOLE TO CONFIRM EXACT LOCATION OF UTILITIES. EXERCISE EXTREME CARE IN EXCAVATING AND WORKING NEAR UTILITIES.
- 2. THE CONTRACTOR SHALL BE RESPONSIBLE FOR ALL DAMAGES TO THE UTILITIES CAUSED BY HIS/HER OPERATION OR NEGLECT AND IN CASES OF INTERRUPTION OF UTILITIES BECAUSE OF OPERATION OR NEGLECT. THE CONTRACTOR IS RESPONSIBLE TO HAVE THE UTILITIES IN SERVICE AS SOON AS POSSIBLE AT THE DIRECTION OF THE ENGINEER AND/OR UTILITIES REPRESENTATIVE.
- 3. THE COST TO REPAIR THE UTILITIES, IF DAMAGED, SHALL BE THE RESPONSIBILITY OF THE CONTRACTOR.



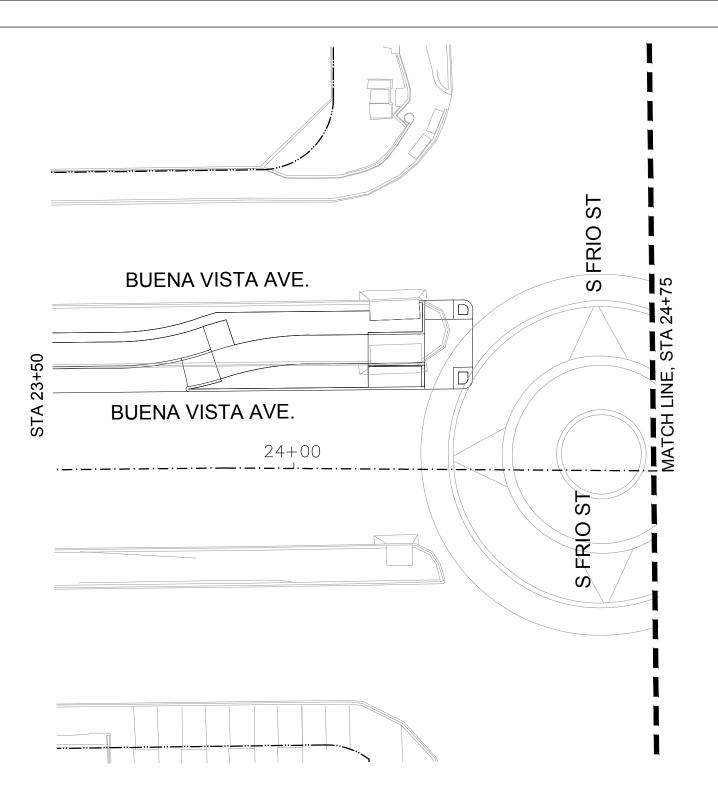



- 1. IRRIGATION PLANS ARE GENERALLY DIAGRAMMATIC AND INDICATIVE OF THE WORK TO BE INSTALLED. IT IS THE INTENT OF THIS DESIGN THAT ALL MAINLINE AND LATERAL PIPES, VALVES, ETC., AND OTHER IRRIGATION SYSTEM APPURTENANCES BE INSTALL IN LANDSCAPE AREAS WHEREVER POSSIBLE AND WITHIN THE PUBLIC RIGHT-OF-WAY.
- 2. THE CONTRACTOR SHALL ROUTE ALL IRRIGATION MAINLINE AND LATERAL PIPE AND SLEEVES AROUND ALL SERVICE LINES, NEW AND EXISTING TREES, UTILITIES, STORM DRAINAGE FACILITIES, ETC., IN ORDER TO AVOID ANY CONFLICTS. INSTALL IRRIGATION PIPE BELOW STORM DRAINAGE PIPES WHERE REQUIRED AND INSTRUCTED.


SLEEVING: INSTALL IN LOCATIONS AS SHOWN ON PLAN. REFER TO PIPE/WIRE SLEEVING CHART ON THIS SHEET FOR SIZE AND TYPE.

#) M = MAINLINE SLEEVE


(#) L = LATERAL SLEEVE

(#) W = WIRING CONDUIT

LIMIT OF WORK

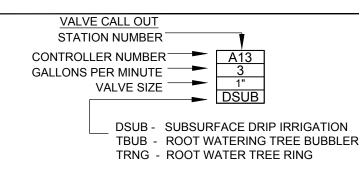



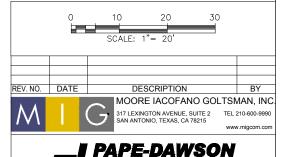



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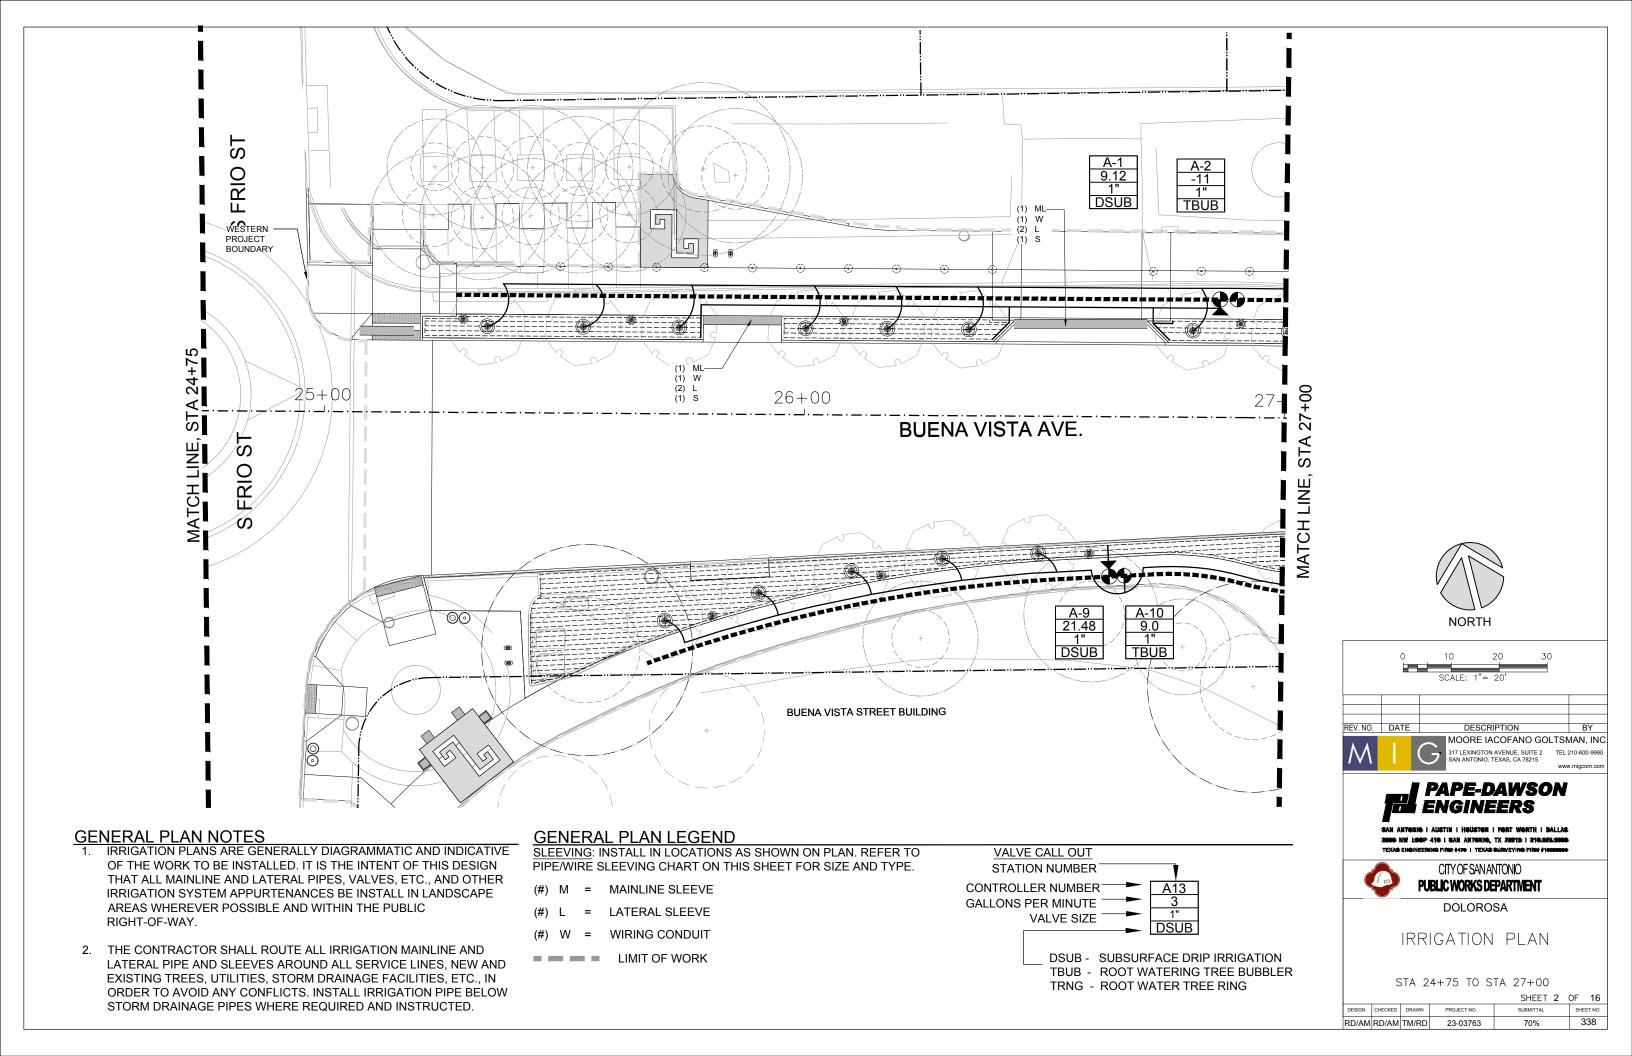
CITY OF SAN ANTONIO
PUBLIC WORKS DEPARTMENT


DOLOROSA

IRRIGATION PLAN

STA 23+00 TO STA 24+75

				SHEET	01 10
DESIGN	CHECKED	DRAWN	PROJECT NO.	SUBMITTAL	SHEET NO.
RD/AM	RD/AM	TM/RD	23-03763	70%	337



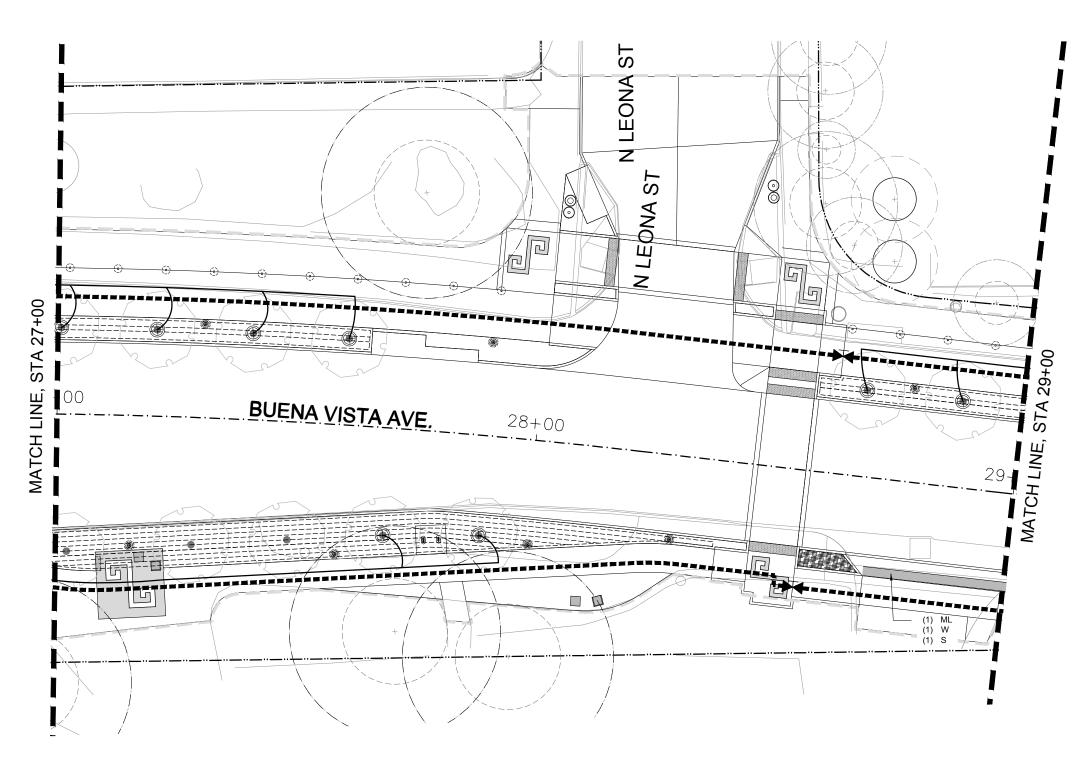




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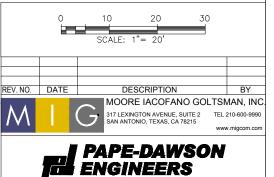
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- LATERAL SLEEVE
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- LIMIT OF WORK



DSUB - SUBSURFACE DRIP IRRIGATION TBUB - ROOT WATERING TREE BUBBLER TRNG - ROOT WATER TREE RING

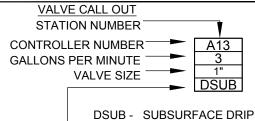





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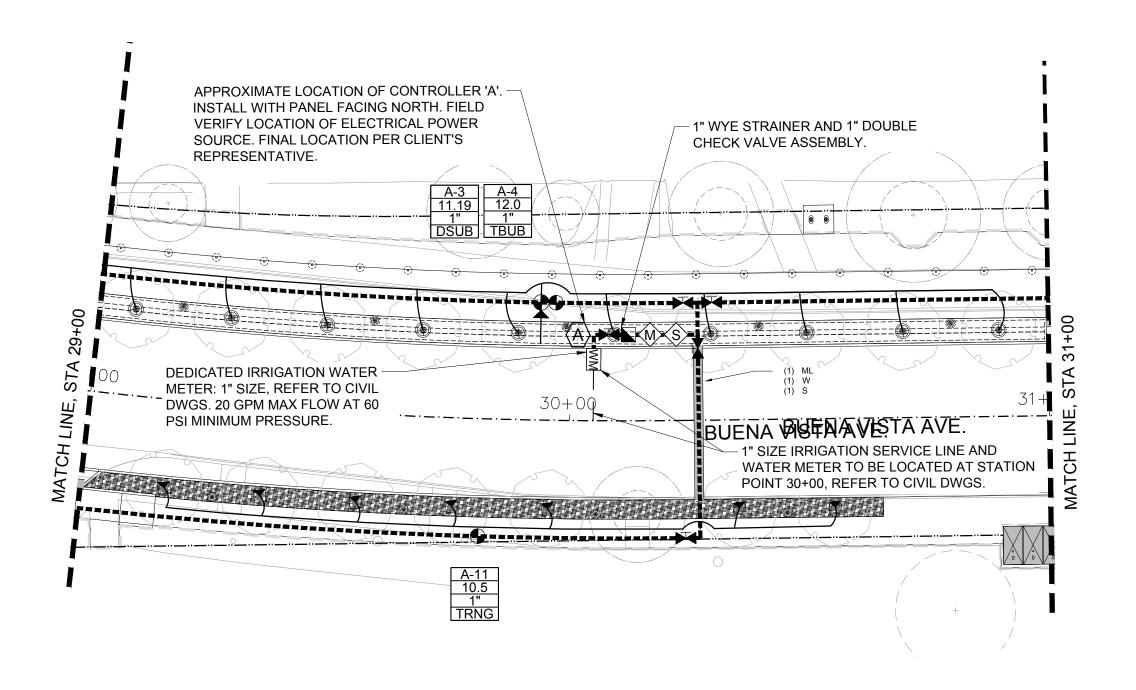
CITYOFSANANTONIO PUBLIC WORKS DEPARTMENT

**DOLOROSA** 

IRRIGATION PLAN

STA 27+00 TO STA 29+00

				SHEET 3	OF 16
DESIGN	CHECKED	DRAWN	PROJECT NO.	SUBMITTAL	SHEET NO.
RD/AM	RD/AM	TM/RD	23-03763	70%	339







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- MAINLINE SLEEVE
- LATERAL SLEEVE
- WIRING CONDUIT
- LIMIT OF WORK





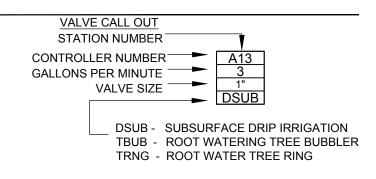



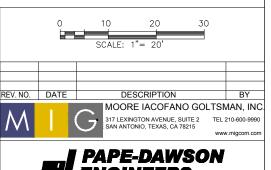


CITYOFSANANTONIO **PUBLIC WORKS DEPARTMENT** 

**DOLOROSA** 

IRRIGATION PLAN

STA 29+00 TO STA 31+00

				SHEET 4	OF	16
DESIGN	CHECKED	DRAWN	PROJECT NO.	SUBMITTAL	SHE	ET NO.
RD/AM	RD/AM	TM/RD	23-03763	70%	3	340

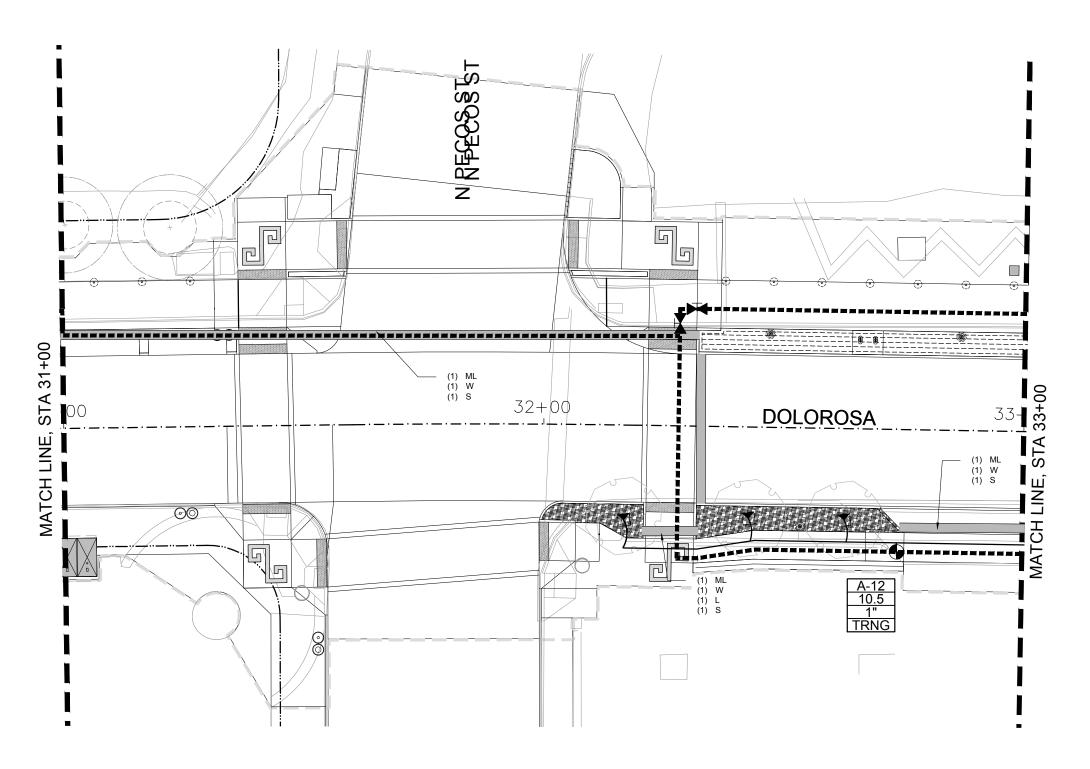





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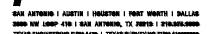
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- LATERAL SLEEVE
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- LIMIT OF WORK





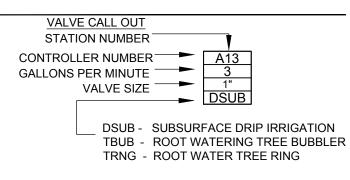

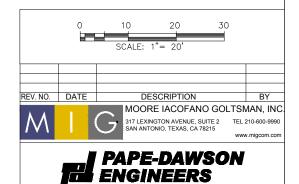

CITYOFSANANTONIO




PUBLIC WORKS DEPARTMENT

**DOLOROSA** 

IRRIGATION PLAN

STA 31+00 TO STA 33+00

				SHEET 0	01 10
DESIGN	CHECKED	DRAWN	PROJECT NO.	SUBMITTAL	SHEET NO.
RD/AM	RD/AM	TM/RD	23-03763	70%	341

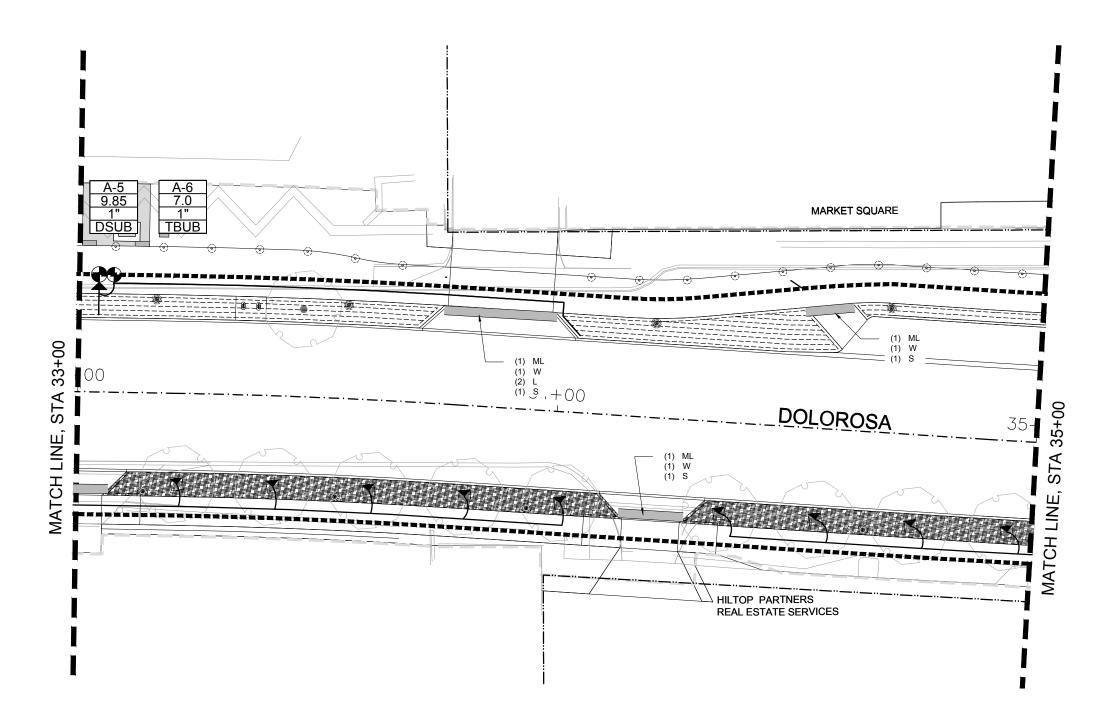


### **GENERAL PLAN NOTES**


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- MAINLINE SLEEVE
- LATERAL SLEEVE
- WIRING CONDUIT
- LIMIT OF WORK





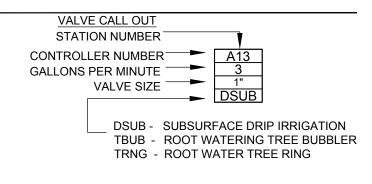

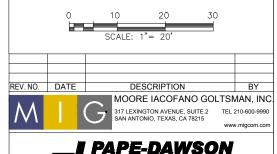

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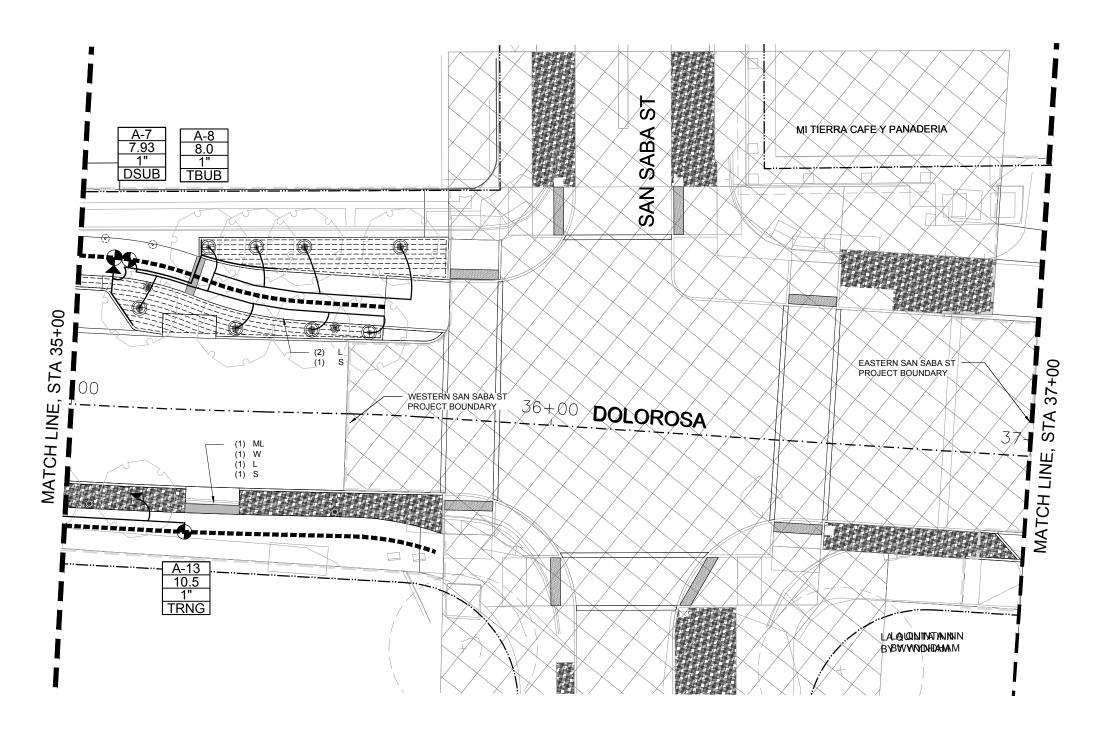
CITYOFSANANTONIO **PUBLIC WORKS DEPARTMENT** 

**DOLOROSA** 

IRRIGATION PLAN

STA 33+00 TO STA 35+00

				SHEET 6	OF 16	
DESIGN	CHECKED	DRAWN	PROJECT NO.	SUBMITTAL	SHEET NO.	
RD/AM	RD/AM	TM/RD	23-03763	70%	342	






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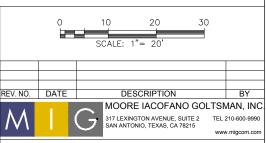
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DSUB - SUBSURFACE DRIP IRRIGATION TBUB - ROOT WATERING TREE BUBBLER TRNG - ROOT WATER TREE RING





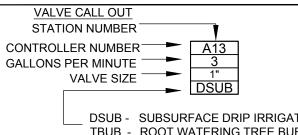

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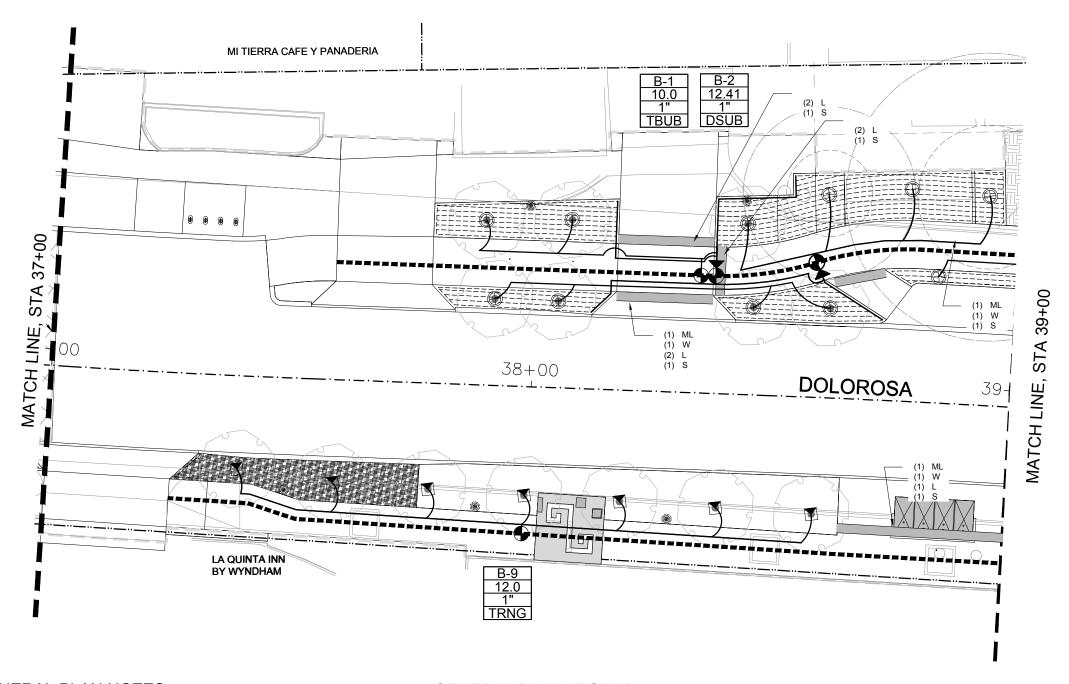
CITYOFSANANTONIO **PUBLIC WORKS DEPARTMENT** 

**DOLOROSA** 

IRRIGATION PLAN

STA 35+00 TO STA 37+00

				SHEEL / C	ור וס	
DESIGN	CHECKED	DRAWN	PROJECT NO.	SUBMITTAL	SHEET NO.	
NA/OS	RD/AM	TM/RD	23-03763	70%	343	






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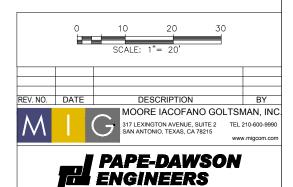
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DSUB - SUBSURFACE DRIP IRRIGATION TBUB - ROOT WATERING TREE BUBBLER TRNG - ROOT WATER TREE RING





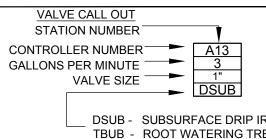

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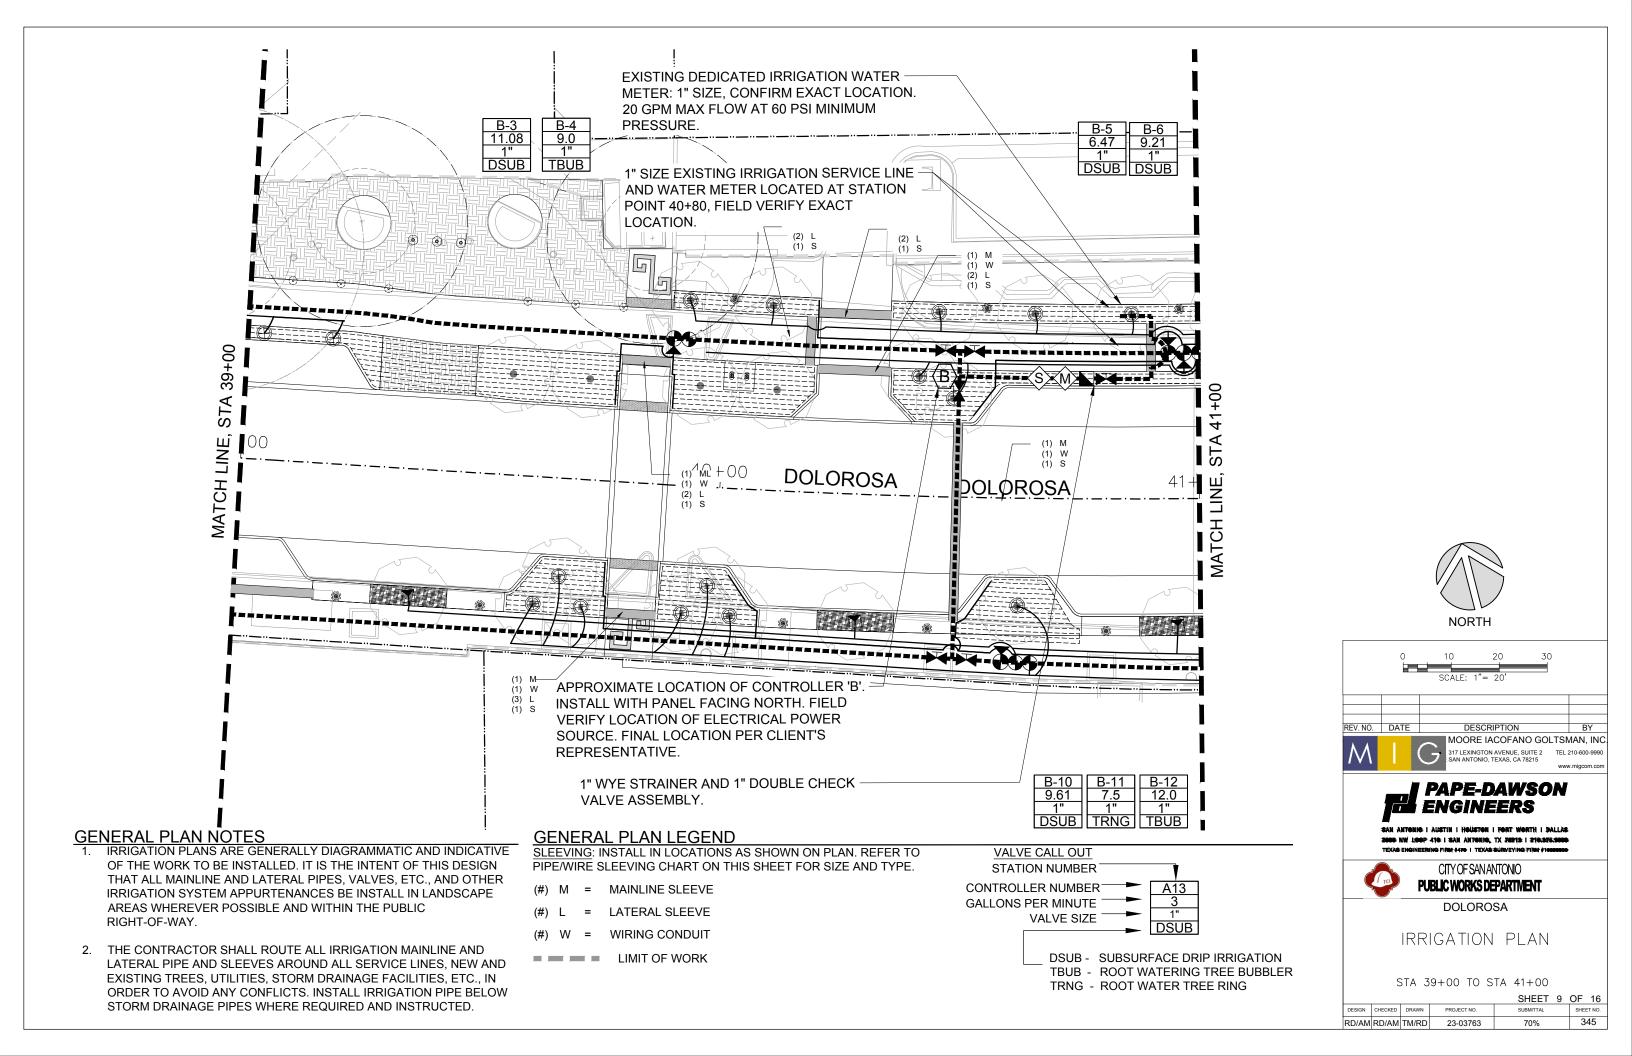
CITYOFSANANTONIO **PUBLIC WORKS DEPARTMENT** 


**DOLOROSA** 

IRRIGATION PLAN

STA 37+00 TO STA 39+00

				SHEET 6	JF 16
DESIGN	CHECKED	DRAWN	PROJECT NO.	SUBMITTAL	SHEET NO.
RD/AM	RD/AM	TM/RD	23-03763	70%	344



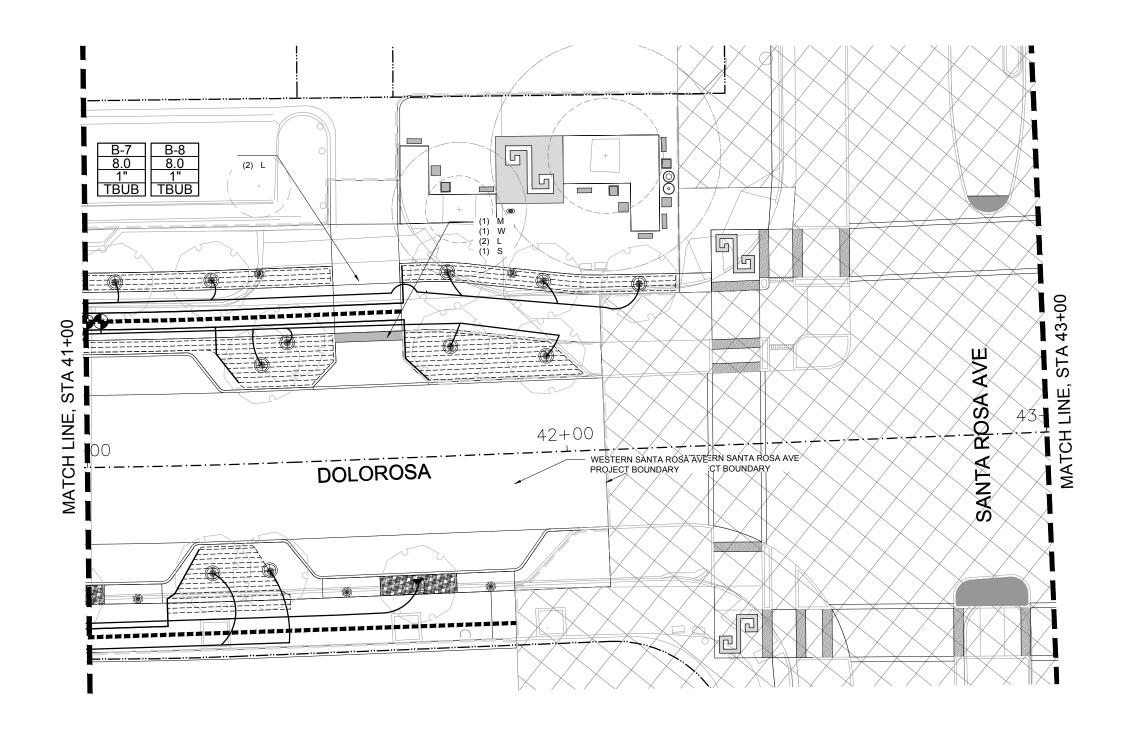



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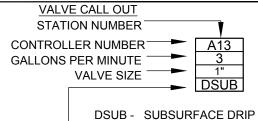
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= MAINLINE SLEEVE

LATERAL SLEEVE


WIRING CONDUIT

LIMIT OF WORK



DSUB - SUBSURFACE DRIP IRRIGATION TBUB - ROOT WATERING TREE BUBBLER TRNG - ROOT WATER TREE RING



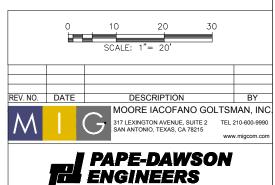



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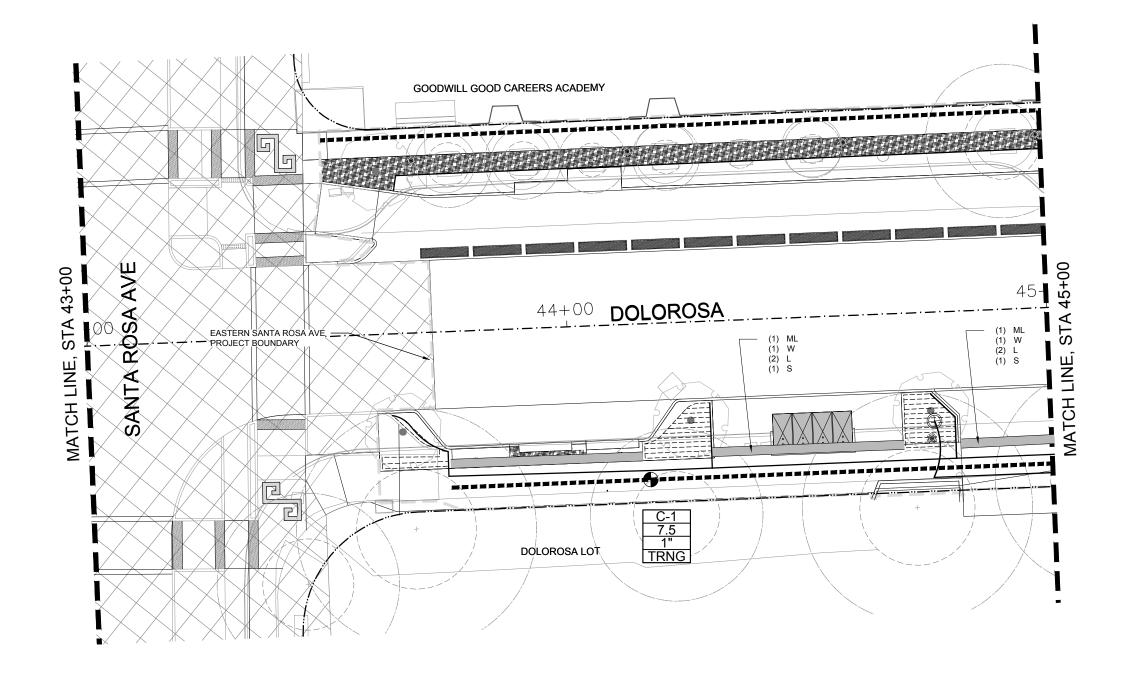
CITYOFSANANTONIO PUBLIC WORKS DEPARTMENT

**DOLOROSA** 

IRRIGATION PLAN

STA 41+00 TO STA 43+00

				SHEET 10	OF 16
DESIGN	CHECKED	DRAWN	PROJECT NO.	SUBMITTAL	SHEET NO.
RD/AM	RD/AM	TM/RD	23-03763	70%	346





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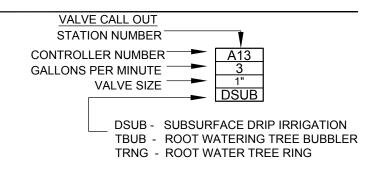
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= MAINLINE SLEEVE


LATERAL SLEEVE

WIRING CONDUIT

LIMIT OF WORK





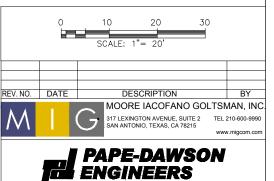






CITYOFSANANTONIO PUBLIC WORKS DEPARTMENT

**DOLOROSA** 


IRRIGATION PLAN

STA 43+00 TO STA 45+00

				SHEEL II	UF 10
DESIGN	CHECKED	DRAWN	PROJECT NO.	SUBMITTAL	SHEET NO.
RD/AM	RD/AM	TM/RD	23-03763	70%	347

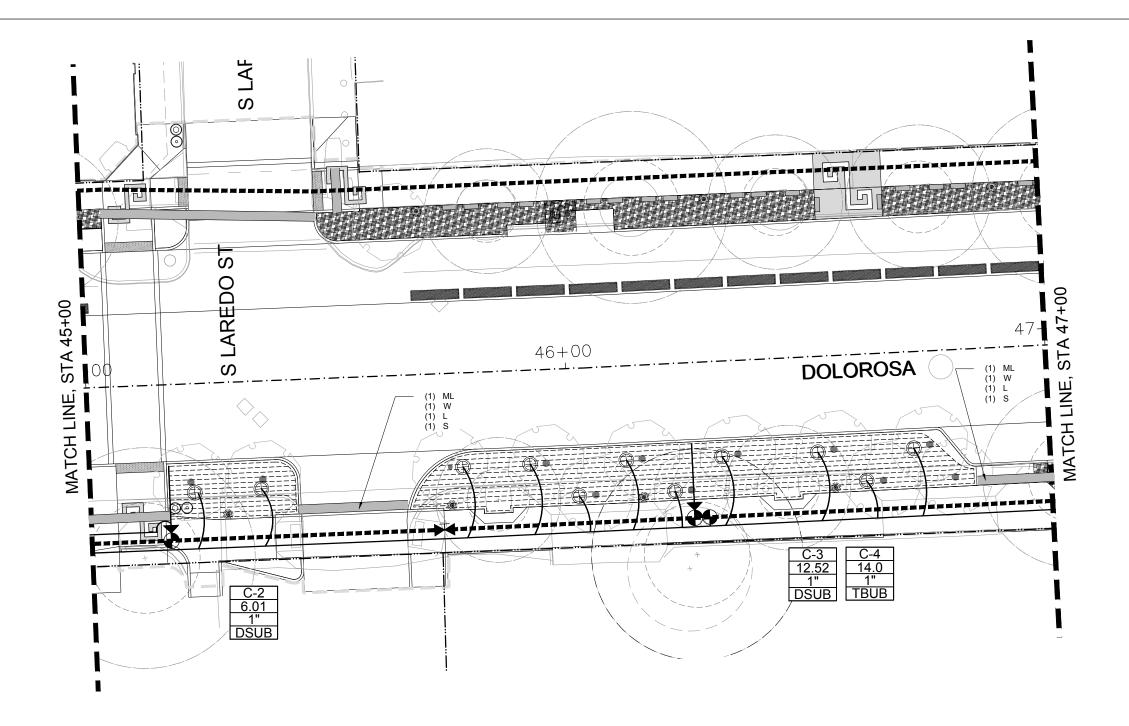



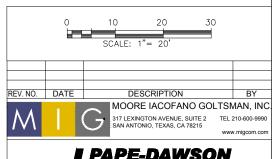

# PAPE-DAWSON ENGINEERS

SAN ANTONIO I AUSTIN I HOUSTON I FORT WORTH I DALLAS.



CITY OF SAN ANTONIO
PUBLIC WORKS DEPARTMENT

DOLOROSA

IRRIGATION PLAN

STA 45+00 TO STA 47+00

 SHEET 12 OF 16

 DESIGN
 CHECKED
 DRAWN
 PROJECT NO.
 SUBMITTAL
 SHEET NO.

 RD/AM
 RD/AM
 TM/RD
 23-03763
 70%
 348

### **GENERAL PLAN NOTES**

- IRRIGATION PLANS ARE GENERALLY DIAGRAMMATIC AND INDICATIVE
  OF THE WORK TO BE INSTALLED. IT IS THE INTENT OF THIS DESIGN
  THAT ALL MAINLINE AND LATERAL PIPES, VALVES, ETC., AND OTHER
  IRRIGATION SYSTEM APPURTENANCES BE INSTALL IN LANDSCAPE
  AREAS WHEREVER POSSIBLE AND WITHIN THE PUBLIC
  RIGHT-OF-WAY.
- 2. THE CONTRACTOR SHALL ROUTE ALL IRRIGATION MAINLINE AND LATERAL PIPE AND SLEEVES AROUND ALL SERVICE LINES, NEW AND EXISTING TREES, UTILITIES, STORM DRAINAGE FACILITIES, ETC., IN ORDER TO AVOID ANY CONFLICTS. INSTALL IRRIGATION PIPE BELOW STORM DRAINAGE PIPES WHERE REQUIRED AND INSTRUCTED.

# **GENERAL PLAN LEGEND**


SLEEVING: INSTALL IN LOCATIONS AS SHOWN ON PLAN. REFER TO PIPE/WIRE SLEEVING CHART ON THIS SHEET FOR SIZE AND TYPE.


#) M = MAINLINE SLEEVE

(#) L = LATERAL SLEEVE


#) W = WIRING CONDUIT

LIMIT OF WORK

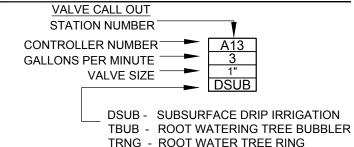

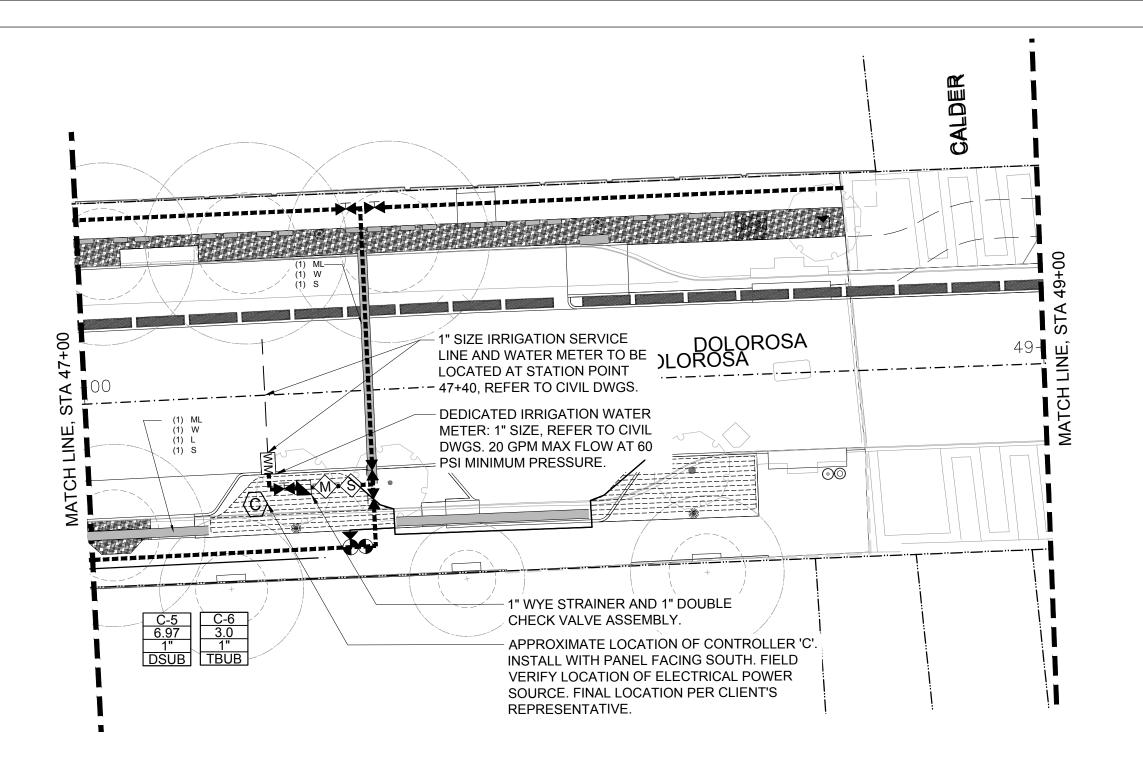



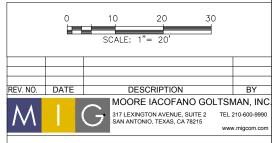

# PAPE-DAWSON ENGINEERS

AN ANTONIO I AUSTIN I HOUSTON I FORT WORTH I DALLAS. 1906 NW LOOP 476 I SAN ANTONIO, TX 20212 I 216.545.0006



CITY OF SAN ANTONIO
PUBLIC WORKS DEPARTMENT

DOLOROSA

IRRIGATION PLAN

STA 47+00 TO STA 49+00

 SHEET 13 OF 16

 DESIGN
 CHECKED
 DRAWN
 PROJECT NO.
 SUBMITTAL
 SHEET NO.

 RD/AM
 RD/AM
 TM/RD
 23-03763
 70%
 349


### **GENERAL PLAN NOTES**


- 1. IRRIGATION PLANS ARE GENERALLY DIAGRAMMATIC AND INDICATIVE OF THE WORK TO BE INSTALLED. IT IS THE INTENT OF THIS DESIGN THAT ALL MAINLINE AND LATERAL PIPES, VALVES, ETC., AND OTHER IRRIGATION SYSTEM APPURTENANCES BE INSTALL IN LANDSCAPE AREAS WHEREVER POSSIBLE AND WITHIN THE PUBLIC RIGHT-OF-WAY.
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### **GENERAL PLAN LEGEND**

<u>SLEEVING</u>: INSTALL IN LOCATIONS AS SHOWN ON PLAN. REFER TO PIPE/WIRE SLEEVING CHART ON THIS SHEET FOR SIZE AND TYPE.

- #) M = MAINLINE SLEEVE
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- LIMIT OF WORK



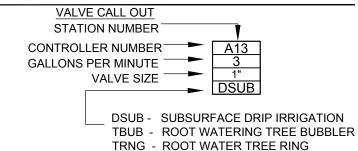


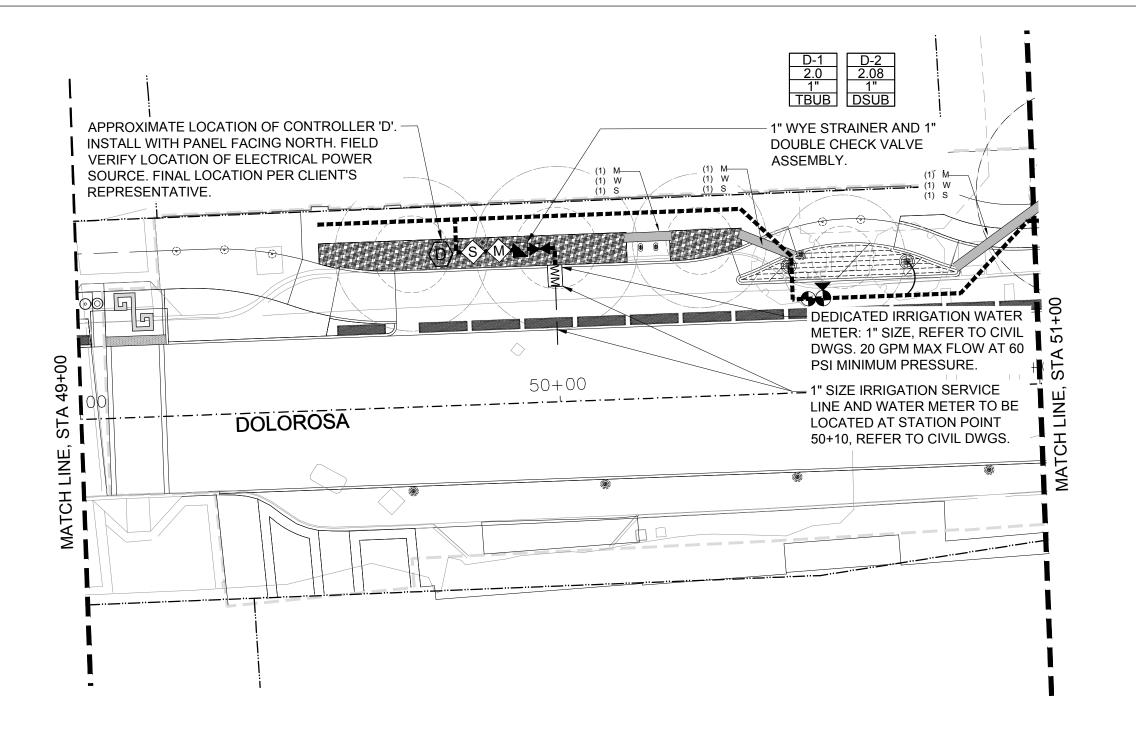


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- #) M = MAINLINE SLEEVE
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- LIMIT OF WORK





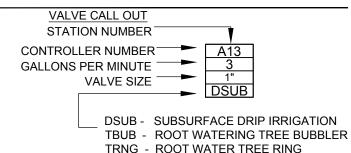

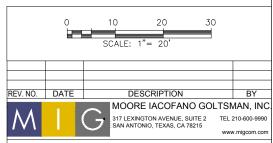

AN ANTONIO I AUSTIN I HOUSTON I FORT WORTH I DALLAS.




CITY OF SAN ANTONIO
PUBLIC WORKS DEPARTMENT

DOLOROSA

IRRIGATION PLAN

STA 49+00 TO STA 51+00

			SHEET 14 OF 16		
DESIGN	CHECKED	DRAWN	PROJECT NO.	SUBMITTAL	SHEET NO.
RD/AM	RD/AM	TM/RD	23-03763	70%	350

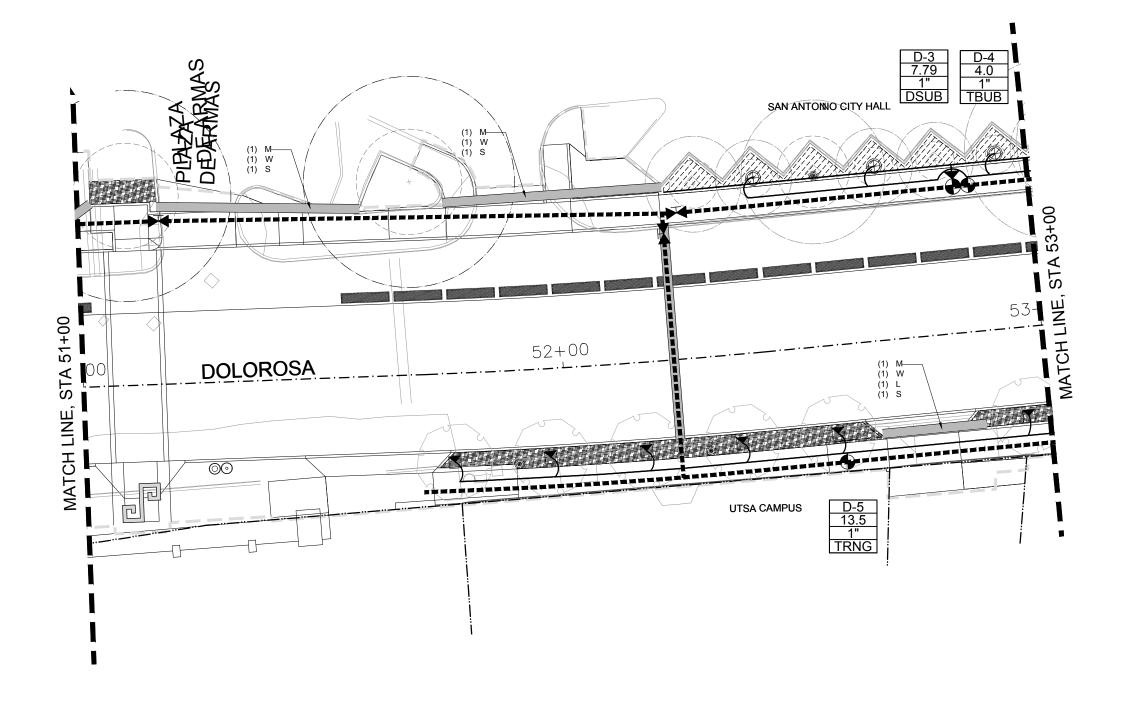




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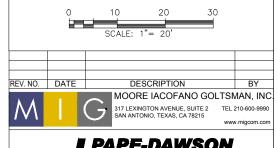
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- #) M = MAINLINE SLEEVE
- (#) L = LATERAL SLEEVE
- (#) W = WIRING CONDUIT
- LIMIT OF WORK







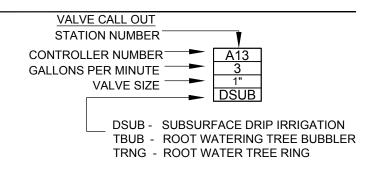

SAN ANTONIO I AUSTIN I HOUSTON I FORT WORTH I DALLAN 2006 NW LOOP 476 I SAN ANTONIO, TX 20219 I 216.505.000




CITY OF SAN ANTONIO
PUBLIC WORKS DEPARTMENT

DOLOROSA

IRRIGATION PLAN

STA 51+00 TO STA 53+00

				SHEET 15	OF 16
DESIGN	CHECKED	DRAWN	PROJECT NO.	SUBMITTAL	SHEET NO.
RD/AM	RD/AM	TM/RD	23-03763	70%	351

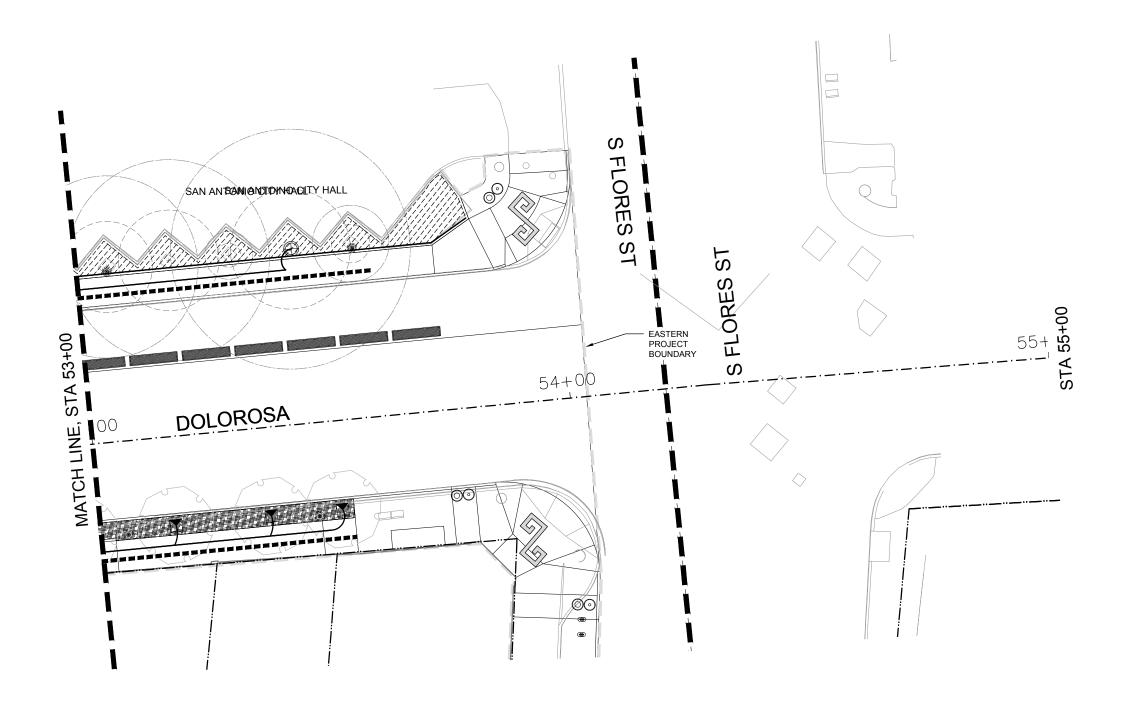




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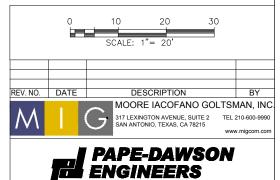
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- (#) L = LATERAL SLEEVE
- (#) W = WIRING CONDUIT
- LIMIT OF WORK







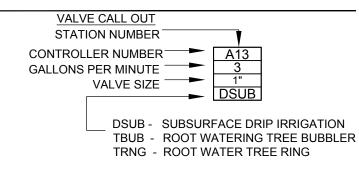

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CITY OF SAN ANTONIO
PUBLIC WORKS DEPARTMENT

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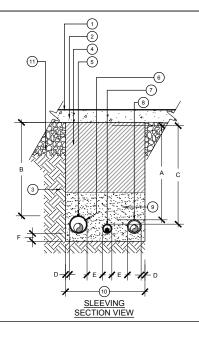
IRRIGATION PLAN

STA 53+00 TO STA 55+00

				SHEET IN	OF 16
DESIGN	CHECKED	DRAWN	PROJECT NO.	SUBMITTAL	SHEET NO.
RD/AM	RD/AM	TM/RD	23-03763	70%	352

DEPTH	Α	В	С	D	E	F
4" AND LARGER	N/A	30"	N/A	1"	4"	2"
3" AND SMALLER	24"	24"	N/A	1"	4"	2"
2-1/2" AND SMALLER	24"	24"	N/A	1"	4"	2"
CONTROL WIRES	N/A	N/A	24"	1"	4"	2"

- DIG SIDES OF TRENCH SQUARE AND CLEAN OF ALL SHARP
- 2. NON-PRESSURE PIPES RUNNING PARALLEL TO EACH OTHER MUST HAVE A MIN. CLEARANCE OF 6" FROM EACH OTHER.
- 3. IRRIGATION PIPES SHALL HAVE A MIN. CLEARANCE OF 24" FROM
- 4. PROVIDE A 24" LOOP IN ALL WIRING AT CHANGES IN DIRECTION.
- 5. CONTRACTOR MUST ADJUST MAINLINE AS REQUIRED TO AVOID OTHER ELEMENTS.
- 6. ALL SLEEVES MUST BE A MIN. OF 2 TIMES THE DIAMETER OF THE
- ALL SLEEVES MUST EXTEND 12" MIN. DISTANCE PAST CURB OR PAVEMENT EDGES.




- 1) FINISH GRADE (2) VEHICULAR OR PEDESTRIAN PAVIN
- (3) UNDISTURBED SOIL
- COMPACTED BACKFILL OVER INITIAL
   SAND BEDDING:
   BENEATH VEHICULAR PAVEMENT
   SHALL BE COMPACTED CLASS II
   AGG, DEPTH AND COMPACTION
   PER ENGINEER'S PLANS
  - BENEATH NON-VEHICULAR PAVEMENT SHALL BE NATIVE SITE SOIL. NO PARTICLES GREATER THAN 1". COMPACT PER SPECS.
- 5 COPPER TRACE WIRE, REFER TO SPECS
- 6 PRESSURE MAINLINE PIPE SLEEVE PER SPECS.
- (7) CONTROL WIRE SLEEVE, PER SPEC
- 8 NON-PRESSURE LATERAL LINE SLEEVE, SEE SPECS.
- (9) INITIAL SAND BACKFILL PER SPECS. PROVIDE 6" BEDDING DEPTH BELOV MAINLINE AND 6" COVER ABOVE MAINLINE. COMPACT PER SPECS.
- 9° MIN. OR AS NEEDED TO PROVIDE FOR A MINIMUM 6" CLEARANCE BETWEEN PIPES.
- PAVEMENT SUBGRADE AS PER ENGINEER'S PLANS

Scale: N.T.S

DEPTH	Α	В	С	D	Е	F
4" AND LARGER	N/A	24"	N/A	1"	6"	2"
3" AND SMALLER	12"	18"	N/A	1"	6"	2"
2-1/2" AND SMALLER	12"	18"	N/A	1"	6"	2"
CONTROL WIRES	N/A	N/A	BELOW MAINLINE	1"	6"	2"

- DIG SIDES OF TRENCH SQUARE AND CLEAN OF ALL SHARP
- 2. NON-PRESSURE PIPES RUNNING PARALLEL TO EACH OTHER MUST HAVE A MIN. CLEARANCE OF 6" FROM EACH OTHER.
- IRRIGATION PIPES SHALL HAVE A MIN. CLEARANCE OF 24" FROM
- 4. PROVIDE A 24" LOOP IN ALL WIRING AT CHANGES IN DIRECTION.
- 5. CONTRACTOR MUST ADJUST MAINLINE AS REQUIRED TO AVOID OTHER ELEMENTS.

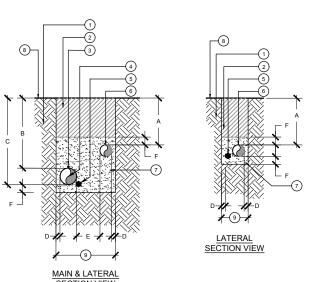


1) UNDISTURBED SOIL

- 2 COMPACTED BACKFILL OVER INITIAL SAND BEDDING. NO PARTICLES GREATER THAN 1". COMPACT PER SPECES
- 3 COPPER TRACE WIRE. REFER TO
- PRESSURE MAINLINE PIPE, PER SPECS.
- (5) CONTROL WIRES, BUNDLED AND TAPED TO SIDE OF MAINLINE AT 10 O.C. (INSTALL WIRES IN CONDUIT FROM CONTROLLER TO MAINLINE).
- (6) NON-PRESSURE LATERAL LINE, PER
- (7) INITIAL SAND BACKFILL PER SPECS. PROVIDE BEDDING DEPTH BELOW MAINLINE AND COVER ABOVE
  MAINLINE/LATERAL PER CHART.
  COMPACT PER SPECS.
- 8 FINISH GRADE
- 9 9" MIN. OR AS NEEDED TO PROVIDE FOR A MINIMUM 6" CLEARANCE BETWEEN PIPES.

Scale: N.T.S.

#### 2 | SLEEVING DETAIL

- 1. INSTALL VALVE BOXES IN GROUND COVER/ SHRUB PLANTING AREAS WHENEVER POSSIBLE
- 2. ALL VALVE BOXES MUST BE PERPENDICULAR TO EDGE OF AREA, ADJACENT PAVING OR CONCRETE CURB AND SET PARALLEL TO EACH OTHER.
- 3. ALL VALVES MUST BE CENTERED AND INSTALLED PLUMB INSIDE VALVE BOX TO FACILITATE ACCESS AND
- 4. ALL VALVES MUST BE INSTALLED IN ITS OWN VALVE BOX
- 6. REFER TO VALVE ASSEMBLY DETAILS FOR VALVE BOXES FINISH ELEVATIONS.
- 7. AVOID EXCESSIVE COMPACTING AROUND VALVE BOXES TO PREVENT COLLAPSE AND DEFORMATION OF
- 8. INSTALL VALVE BOX EXTENSIONS BY VALVE MANUFACTURER AS REQUIRED TO COMPLETELY ENCLOSE
- 9. LOCATION OF VALVE ASSEMBLIES SHALL BE STAKED FOR APPROVAL BY OWNER'S REPRESENTATIVE
- 10. ALL VALVE BOX LIDS MUST BE LABELED BY HOT IRON BRANDING
- YS WYE STRAINER
- CV CHECK VALVE
- MV MASTER VALVE FS - FLOW SENSOR
- RCV REMOTE CONTROL VALVE
- QCV QUICK COUPLER VALVE
- GV ISOLATION GATE VALVE E - PULL BOX/ SPLICE BOX
- BV ISOLATION BALL VALVE

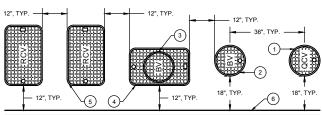

- (1) 10" ROUND VALVE BOX PER SPECS FOR QUICK COUPLER VALVE, TYP.
- (2) 10" ROUND VALVE BOX PER SPECS FOR QUICK COUPLER ISOLATION BALL VALVE, TYP.
- 10" ROUND VALVE BOX PER SPECS FOR MAINLINE ISOLATION GATE VALVE, TYP.
- (4) RECTANGULAR VALVE BOX PER SPECS FOR MAINLINE ISOLATION BALL VALVE, TYP. (5) RECTANGULAR VALVE BOX PER SPECS FOR REMOTE CONTROL VALVE ASSEMBLIES, TYP.
- (6) EDGE OF AREA, SIDEWALK, CONCRETE CURB, ETC., TYP.

## 1 TYPICAL TRENCHING DETAIL


- (1) FINISH GRADE AT PLANTER (2) FINISH GRADE AT TURF AREA
- 3 10" ROUND VALVE BOX W/ BOLT DOWN COVER, AND SS HARDWARE
- 4 ISOLATION GATE VALVE PER LEGEND AND SPECS.
- 5 PVC MAINLINE PER LEGEND AND SPECS. USE PVC SCH. 80 45° ELL TO DEPTH PER SPECS.
- (6) BRASS NIPPLE. 2 QTY., TYP
- 7 PVC. SCH. 80 MALE ADAPTERS, 2
- (8) CONCRETE BRICK SUPPORTS, THREE (3) SPACED EQUALLY ALONG PERIMETER BOTTOM.
- 9 LANDSCAPE FABRIC AND 1/4" GALV WIRE MESH, TYP.
- 10 NATIVE SOIL COMPACTED TO 95% R.C.
- 3/8" PEA GRAVEL; 6" MINIMUM DEPT BELOW VALVE BOX. EXTEND 6" BEYOND VALVE BOX WALL

# NOTES:


- BALL VALVE MUST BE INSTALLED IN VALVE BOX TO ALLOW PROPER OPERATION OF BALL VALVE HANDLE.
- ALL THREADED FITTINGS MUST HAVE 3/4" TEFLON TAPE OR PASTE. 3. PROVIDE 45° ELLS TO ACHIEVE BALL VALVE HEIGHT PER
- 4. WHEN MAINLINE IS TERMINATED AT THE VALVE, EXTEND MAINLINE 48" BEYOND VALVE AND CAP.

# 3 ISOLATION GATE VALVE (3" & SMALLER)

# 4 VALVE BOX LAYOUT

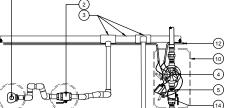

INDIVIDUAL QUICK COUPLER VALVE/ REMOTE CONTROL VALVE PLAN VIEW DIAGRAM

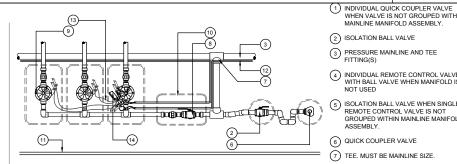

- 1. ALL THREADED CONNECTIONS MUST HAVE TEFLON TAPE (PVC/ BRASS) OR PASTE (BRASS ONLY).
- 2. REMOTE CONTROL VALVES SHALL BE INSTALLED WITH THE LARGEST VALVE AND GPM FLOW INSTALLED FIRST ON THE MANIFOLD, WITH THE SMALLER VALVES AND CAPACITIES TRANSITIONING FROM THERE.
- 3. REFER TO DETAIL #/L#.#.# FOR ALL ISOLATION BALL VALVE REQUIREMENTS.
- 4. REFER TO DETAIL #/L#.#.# FOR QUICK COUPLER VALVE REQUIREMENTS.
- 5. REFER TO DETAIL #/L#.#, 7/L2.5.2 FOR REMOTE CONTROL VALVE REQUIREMENTS.
- 6. REFER TO DETAIL #/L#.#.# FOR VALVE BOX LAYOUT REQUIREMENTS.
- 7. REFER TO DETAIL #-#/L#.#.# FOR PRESSURE MAINLINE AND NON-PRESSURE LATERALS PIPE REQUIREMENTS.

# 6 MANIFOLD INSTALLATION

(4) INDIVIDUAL REMOTE CONTROL VALVE WITH BALL VALVE WHEN MANIFOLD IS (5) ISOLATION BALL VALVE WHEN SINGLE REMOTE CONTROL VALVE IS NOT GROUPED WITHIN MAINLINE MANIFOLE (6) QUICK COUPLER VALVE 7) TEE. MUST BE MAINLINE SIZE. (10) VALVE BOX, TYP. (12) 2-WIRE DECODER CABLE

# (8) ISOLATION GATE VALVE OR BALL VALVE. VALVE MUST BE MAINLINE SIZE. 9 MANIFOLD VALVES TOGETHER WHEN WITHIN 20 FEET OF EACH OTHER. (1) EDGE OF AREA, ADJACENT PAVING OR CONCRETE CURB

(13) 2-WIRE DECODER CABLE TO OTHER RCV/DECODERS

(14) DECODERS

DESCRIPTION REV. NO. MOORE IACOFANO GOLTSMAN, INC 17 LEXINGTON AVENUE, SUITE 2 TEL 210-600-9990 AN ANTONIO, TEXAS, CA 78215 PAPE-DAWSON **ENGINEERS** 



**CITY OF SAN ANTONIO** PUBLIC WORKS DEPARTMENT


NING FIRM #470 | TEXAS SURVEYING FIRM #10

2006 NW 1007 416 | SAN ANTONIO, TX 20215 | 218,575,5000


**DOLOROSA** 

# LANDSCAPE IRRIGATION **DETAILS**

				SHEET I	JI J
DESIGN	CHECKED	DRAWN	PROJECT NO.	SUBMITTAL	SHEET NO.
RD/AM	RD/AM	TM/RD	23-03763	70%	353

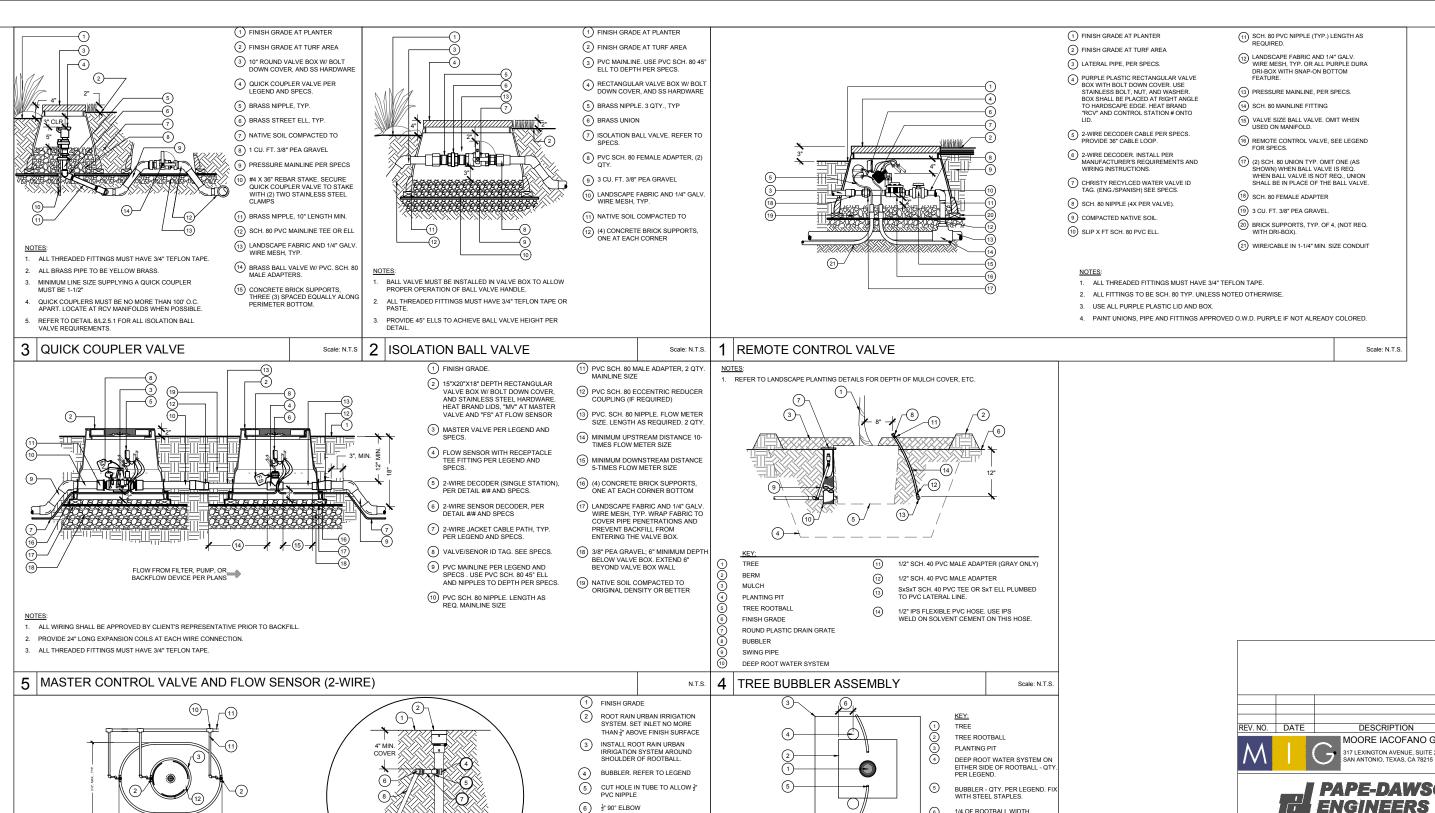

6 TREE BUBBLER ASSEMBLY AT BOX TREE

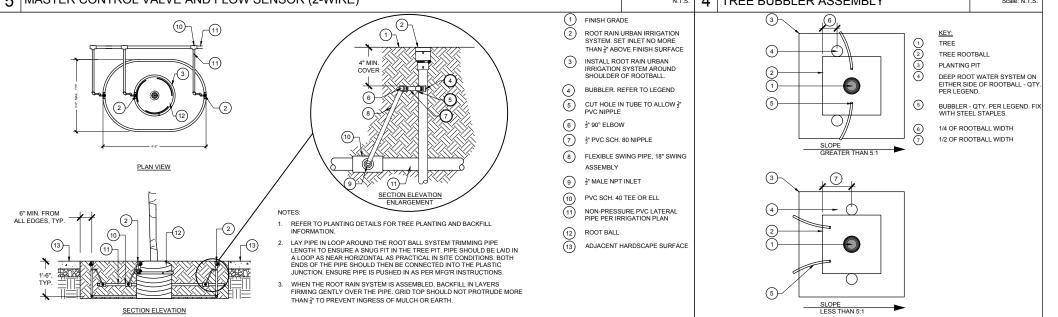

7 TREE IRRIGATION @ DECOMPOSED GRANITE AREAS




PUBLIC WORKS DEPARTMENT

**DOLOROSA** 

LANDSCAPE IRRIGATION **DETAILS** 

				SHEET Z	Jr 5
DESIGN	CHECKED	DRAWN	PROJECT NO.	SUBMITTAL	SHEET NO.
RD/AM	RD/AM	TM/RD	23-03763	70%	354

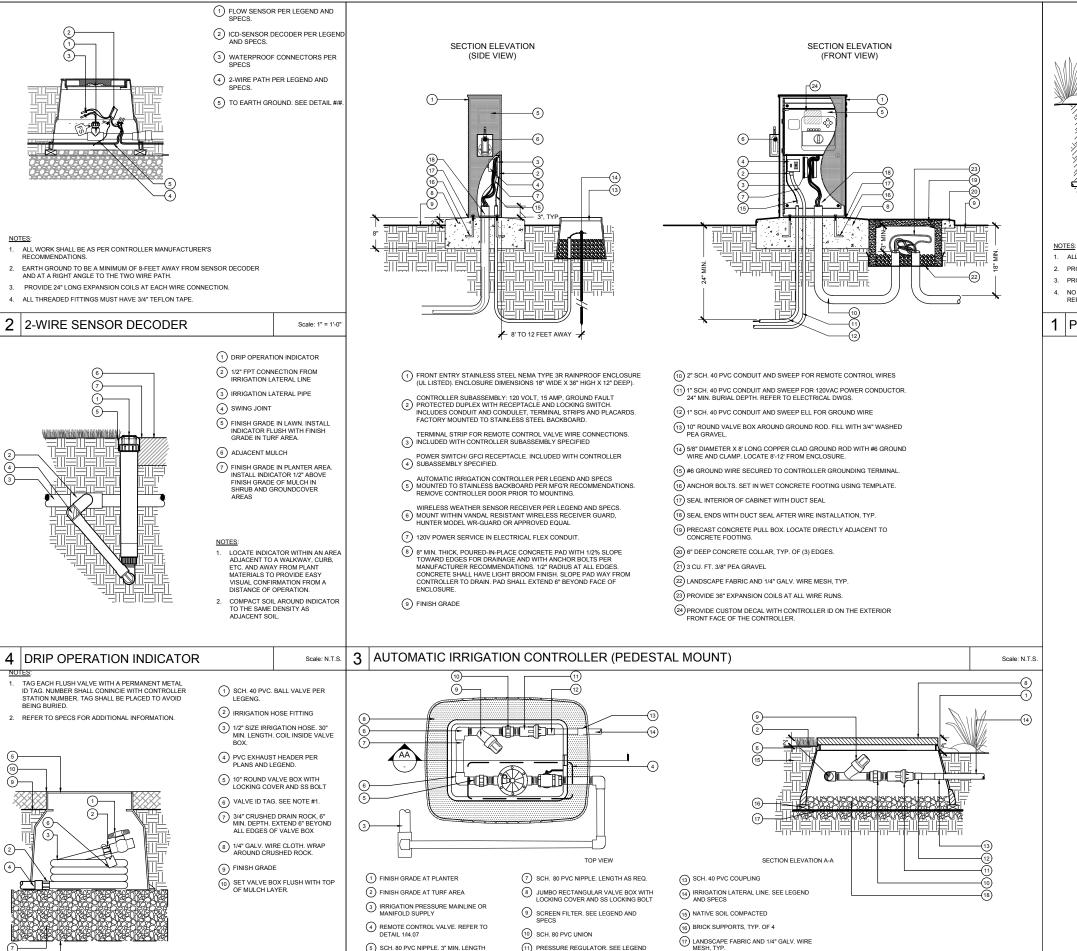

11) PRESSURE REGULATOR. SEE LEGEND AND SPECS


(12) SCH. 80 PVC MALE ADAPTER

18 3 CU. FT. 3/4" PEA GRAVEL

(5) SCH. 80 PVC NIPPLE. 3" MIN. LENGTH 6 SCH. 80 PVC ELL (TxT)

6 MANUAL FLUSH VALVE

5 REMOTE CONTROL DRIP VALVE ASSEMBLY

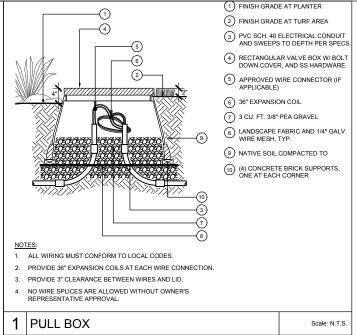





LANDSCAPE IRRIGATION **DETAILS** 

PUBLIC WORKS DEPARTMENT

**DOLOROSA** 

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DESIGN	CHECKED	DRAWN	PROJECT NO.	SUBMITTAL	SHEET NO.
RD/AM	RD/AM	TM/RD	23-03763	70%	355

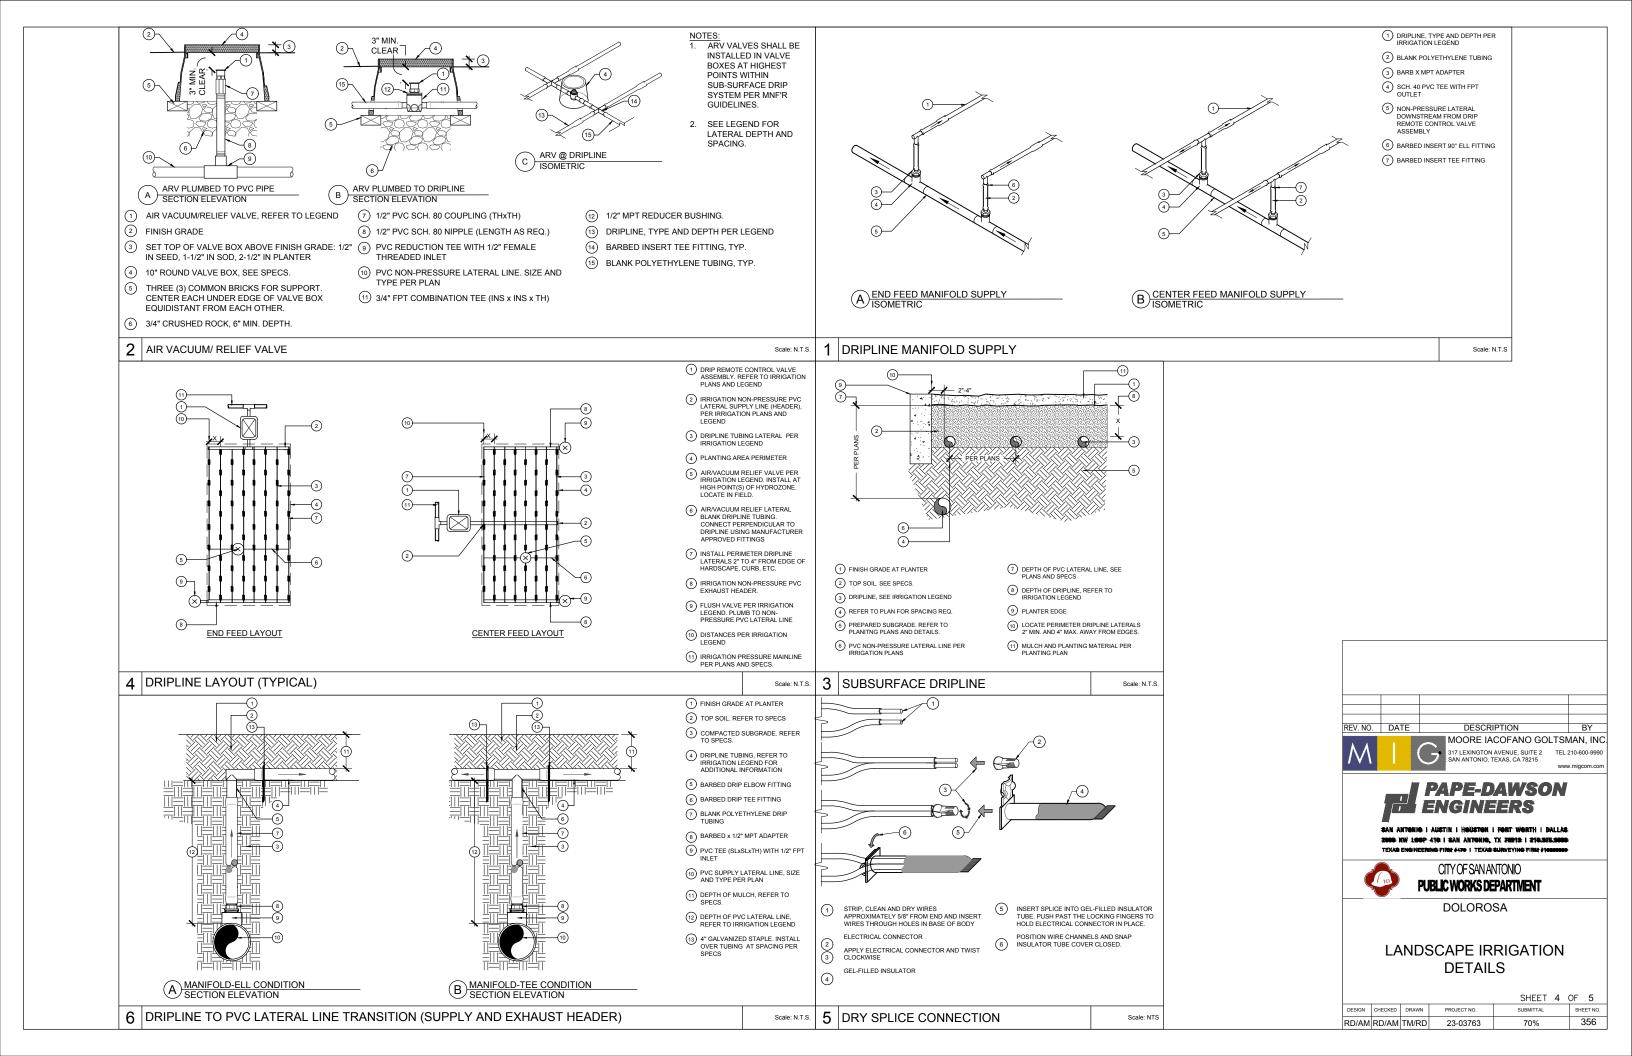

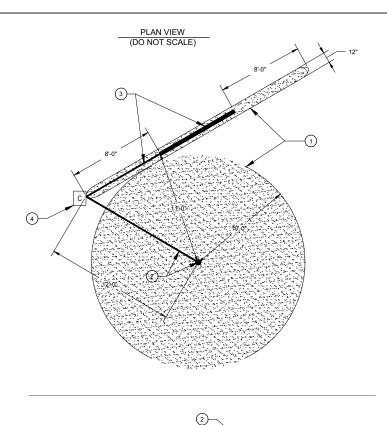

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SECTION ELEVATION (DO NOT SCALE)

1 ELECTRODE SPHERE OF INFLUENCE BOUNDARIES.

(2) GROUND ROD WITH PRE-WELDED INSULATED CONDUCTOR (58° DIA. X 10' LONG), DRIVE INTO GROUND IN A VERTICAL POSITION OR AN OBLIQUE ANGLE NOT TO EXCEED 45°. USE WHEN POSSIBLE TO DRIVE STAKE INTO GROUND.

(3) COPPER GROUND PLATE WITH PRE-WELDED INSULATED CONDUCTOR (SIZE: 4" X 96" X 0.0625"). USE WHEN IMPOSSIBLE TO DRIVE STAKE INTO GROUND OR WHEN DIRECTED BY CONTROLLER MANUFACTURER.

4 AUTOMATIC IRRIGATION CONTROLLER. REFER TO IRRIGATION LEGEND AND DWGS.

5) PVC SWEEP ELL, 1-1/2" MIN.

(6) EARTH CONTACT MATERIAL

(7) FINISH GRADE

8 30" MINIMUM OR BELOW FROST LINE, WHICHEVER IS DEEPER.



 THE GROUND GRID COMPONENTS MUST BE INSTALLED WITH THE DIMENSIONAL RELATIONSHIP SHOWN IN THE DETAIL DO NOT INSTALL ANY OTHER WIRES, CABLES, AND ELECTRONIC EQUIPMENT WITHIN THE SPHERE OF INFLUENCE OF THE GROUNDING ELECTRODES.

 INSTALLATION OF ALL COMPONENTS AND MUST MEET OR EXCEED THE AMERICAN SOCIETY OF IRRIGATION CONSULTANTS (ASIC) EARTH GROUNDING GUIDELINES AND BE AS APPROVED BY AUTOMATIC IRRIGATION CONTROLLER MANUFACTURER'S.

 IT IS THE RESPONSIBILITY OF THE CONTRACTOR TO CONNECT THE CONTROLLER TO EARTH GROUND IN ACCORDANCE WITH ARTICLE 250 OF THE NATIONAL ELECTRICAL CODE (NEC).

4. WHEN UTILIZING THE COPPER GROUND PLATE METHOD, THE CONTRACTOR SHALL UTILIZE A MINIMUM OF 100 LBS OF EARTH CONTACT MATERIAL. SPREAD MATERIALS OT HAT IT SURROUNDS THE COPPER PLAT EVENLY ALONG ITS LENGTH WITHIN A 6" WIDE TRENCH.

 SALTS, FERTILIZERS, BENTONITE CLAY, CEMENT, CODE, CARBON, AND OTHER CHEMICALS ARE NOT BE BE USED TO IMPROVED SOIL CONDUCTIVITY.

 ALL GROUNDING ELECTRODES SHALL BE UL LISTED OR MANUFACTURED TO MEET NEC CODE.

 NO SPLICES ALLOWED UNLESS USING EXOTHERMIC WELDING PROCESS AND APPROVED BY CITY'S REPRESENTATIVE.

INSTALL ALL GROUNDING CIRCUIT COMPONENTS IN STRAIGHT LINES. WHEN NECESSARY TO MAKE A TURN OR BEIND, IT SHALL BE DONE IN A SWEEPING CURVE WITH A MINIMUM RADIUS OF 8" AND A MINIMUM INCLUDED ANGLE OF


9. THE EARTH-TO-GROUND RESISTANCE IS TO BE MEASURED USING A MEGGER
OR OTHER SIMILAR INSTRUMENT, AND THE READING IS TO BE NO MORE THAN
10 OHMS. IF THE RESISTANCE IS MORE THAN 10 OHMS, ADDITIONAL GROUND
PLATES AND EARTH CONTACT MATERIAL ARE TO BE INSTALLED USING ASIC

10. IT IS REQUIRED THAT THE SOIL SURROUNDING COPPER ELECTRODES WITHIN THE SPHERE OF INFLUENCE BE KEPT AT A MNIMUM MOISTURE LEVEL OF 15% (BY VOLUME) AT ALL TIMES.

11. ALL GROUNDING COMPONENTS MUST BE CONNECTED TO THE EQUIPMENT BEFORE ANY OTHER CONNECTION IS MADE.

1 GROUNDING ROD/PLATE


Scale: N.T.S.

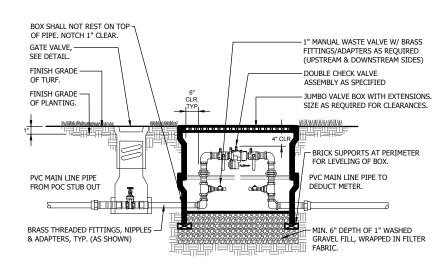

#### NOTES

- INSTALL QUICK COUPLING VALVE IMMEDIATELY
   DOWNSTREAM FROM DCVA FOR WINTERIZATION
   PURPOSES.
- DOVA TO BE ENCLOSED IN VALVE BOX. ALLOW SUFFICIENT ROOM FOR ACCESS TO VALVES AND TEST COCKS.
- ALL THREADED FITTINGS TO BE TEFLON PASTE
- COATED PRIOR TO CONNECTION.

  ASSEMBLY TO BE TESTED AFTER INSTALLATION BY A CERTIFIED BACKFLOW TESTER PRIOR TO OPERATING SYSTEM.

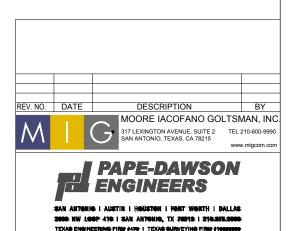



CITY OF SAN ANTONIO
PUBLIC WORKS DEPARTMENT

DOLOROSA

LANDSCAPE IRRIGATION DETAILS

 SHEET 5 OF 5

 DESIGN CHECKED DRAWN PROJECT NO.
 SUBMITTAL
 SHEET NO.

 RD/AM RD/AM TM/RD
 23-03763
 70%
 357


2 DOUBLE CHECK VALVE BACKFLOW PREVENTER IN VAULT


le: N.T.S.

PLANT SCHEDULE							Р
SHADE TREES	CODE E	BOTANICAL NAME / COMMON NAME	CONT	QTY		WATER USE	1.
a e	QUE MUH	Quercus muhlenbergii / Chinkapin Oak	100 Gal. / 4" Cal.	19		MEDIUM	
	QUE POL	Quercus polymorpha `Monterey` / Monterey Oak	100 Gal. / 4" Cal.	49		MEDIUM	
	ULM CRA	Ulmus crassifolia / Cedar Elm	100 Gal. / 4" Cal.	24		LOW	2.
UNDERSTORY & SMALL TREES	CODE	BOTANICAL NAME / COMMON NAME	CONT		Add inc	h caliber for on	
John Charles	CER TEX	Cercis canadensis texensis / Texas Redbud	65 Gal.	17		LOW	
( ° )	SOP SEC	Sophora secundiflora / Mountain Laurel	65 Gal.	28		MEDIUM	
			mm				
SHRUBS	CODE	BOTANICAL NAME / COMMON NAME	CONT				
***	DIE GRA	Dietes grandiflora / African Iris	2 Gal.	130		LOW	
	CYA FAL	Cyrtomium falcatum / Holly Fern	2 Gal.	28		LOW	
<b>⊕</b>	HAM PAT	Hamelia patens / Firebush	3 Gal.	47		LOW	
	MAH AQU	Mahonia aquifolium / Mahonia	3 Gal.	71		MEDIUM	
$\odot$	MAL ARB	Malvaviscus arboreus drummondii / Turks Cap	5 Gal.	69		MEDIUM	
	PLU AUR	Plumbago auriculata / Blue Plumbago	5 Gal.	270		MODERATE	
NOTE: 50% BLUE AND 50%	SAL FAR	Salvia farinacea 'Henry Duelberg' / Blue Salvia	2 Gal.	208		MODERATE	
PINK SALVIA, MIX EVERY OTHER PLANT IN LAYOUT	SAL GRE	Salvia gregii 'Sierra Linda' / Pink Autumn Salvia	2 Gal.	208		LOW	
	STA COC	Stachys coccinea / Texas Betony	1 Gal.	164		LOW	
YUCCA, AGAVE, & CACTUS	CODE	BOTANICAL NAME / COMMON NAME	CONT				
	HES PAR	Hesperaloe parvifolia / Red Yucca	5 Gal.	16		VERY LOW	
me and a second	YUC REC	Yucca recurvifolia / Soft Leaf Yucca	5 Gal.	12		VERY LOW	
GROUND COVERS	CODE	BOTANICAL NAME / COMMON NAME	CONT S	PACING	<u>QTY</u>		
	LIR MUS	Liriope muscari / Liriope	1 Gal. 12	2" o.c.	2,033 SF	MEDIUM	
	SCU SUF	Scutellaria suffrutescens / Pink Skullcap	1 Gal. 12	2" o.c.	93	LOW	

# **PLANTING NOTES**

- 1. THE PLANTING PLANS INDICATE PLANTING LOCATION AND QUANTITIES. THE CONTRACTOR SHALL VERIFY ALL QUANTITIES. THE AREAS OF GROUNDCOVER AND PERENNIAL PLANTINGS ARE APPROXIMATE. THE CONTRACTOR SHALL BE RESPONSIBLE FOR PROVIDING THE REQUIRED NUMBER OF PLANTS TO COVER THE AREAS SHOWN ON THESE PLANS.
- 2. REFER TO THE PLANT LIST FOR PLANT SIZES. REFER TO THE SPECIFICATIONS FOR SOIL PREPARATION, SOIL AMENDMENTS, FERTILIZER AND ADDITIONAL PLANTING REQUIREMENTS.

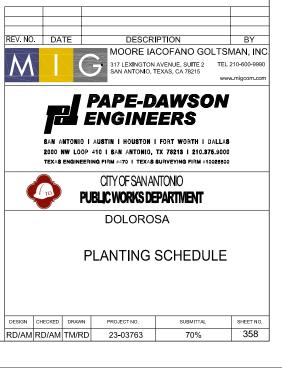

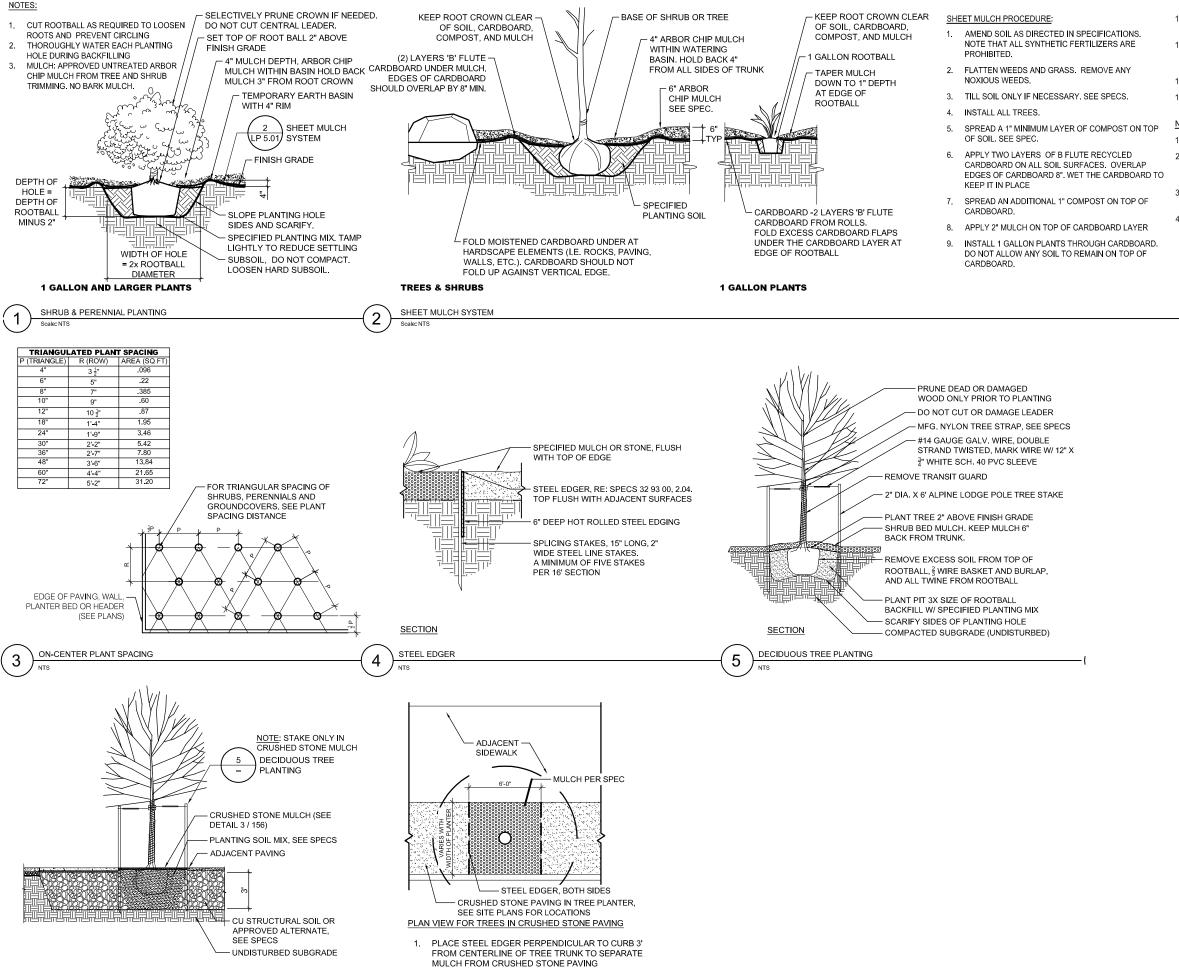

TREE PLANTING CRUSHED STONE MULCH

7

TREE PLANTING AT STRUCTURAL SOIL

6

10. INSTALL ALL DRIP LINES UNDERNEATH THE

11. INSTALL 4" PLANTS AND PLUGS OR LINERS INTO MULCH AND COMPOST LAYERS (DO NOT PUNCH THROUGH CARDBOARD)

12. DO NOT BURY ROOT CROWNS OF PLANTS IN MULCH.

13. MAINTENANCE: REPLENISH MULCH AS NEEDED TO MAINTAIN SPECIFIED MULCH DEPTH


#### NOTES:

1. PLACE SHEET MULCH ON ALL SOIL SURFACES.

2. ALL CARDBOARD (100% RECYCLED B FLUTE CARDBOARD ROLLS) IS TO BE COVERED WITH A

3. MULCH IS TO BE FROM LOCAL CHIPPED LANDSCAPE TRIMMINGS.

 WHERE SLOPE IS GREATER THAN 3:1 DO NOT USE CARDBOARD. APPLY ONLY A 2" LAYER OF COMPOST COVERED WITH 4" MULCH.

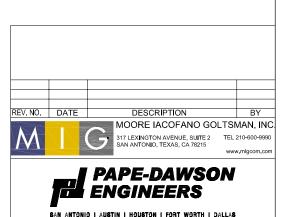




PUBLIC WORKS DEPARTMENT


DOLOROSA

2000 NW LOOP 410 | SAN ANTONIO, TX 78213 | 210,375,9000

PLANTING DETAILS

DESIGN	CHECKED	DRAWN	PROJECT NO.	SUBMITTAL	SHEET NO.
RD/AM	RD/AM	TM/RD	23-03763	70%	359

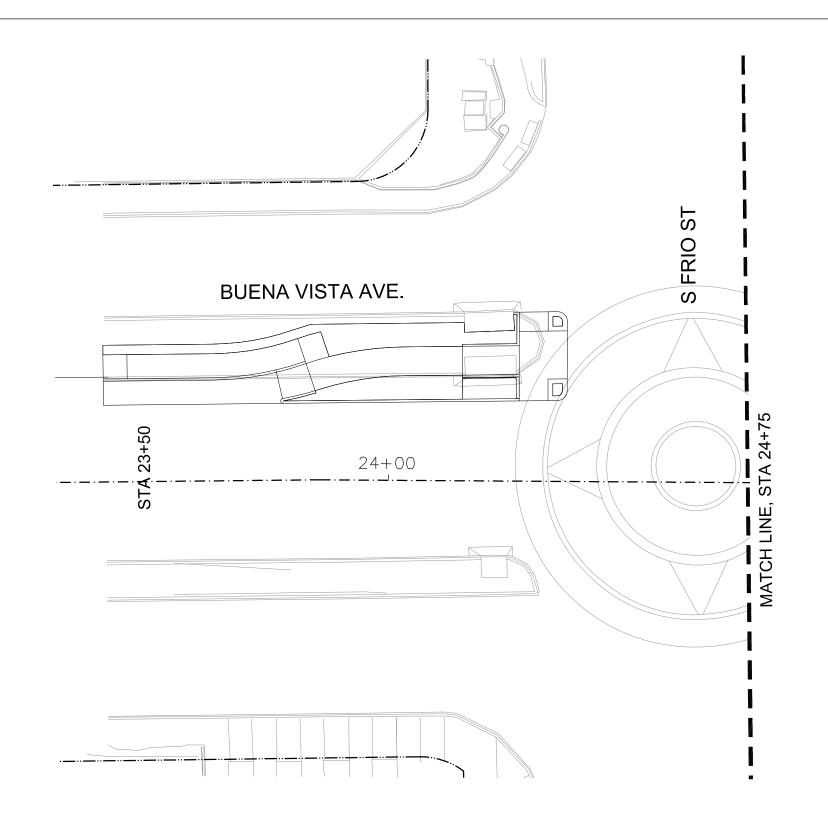

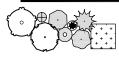

PLANT SYMBOLS, SEE PLANT SCHEDULE



CRUSHED STONE MULCH



EXISTING LANDSCAPE TO REMAIN (SEE PLANTING NOTES)


STRUCTURAL SOIL



(E) TREE TO BE PROTECTED WITH ROOT ZONE (SEE INVENTORY SHEET)



TREE TO BE REMOVED

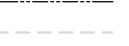


RIGHT OF WAY

LIMIT OF WORK

MATCHLINE





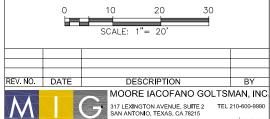



SAN ANTONIO I AUSTIN I HOUSTON I FORT WORTH I DALLAS 2000 NW LOOP 410 I SAN ANTONIO, TX 78213 I 210.376,9000 Texas engineering firm #470 I Texas Surveying Firm #10028800



CITY OF SAN ANTONIO PUBLIC WORKS DEPARTMENT


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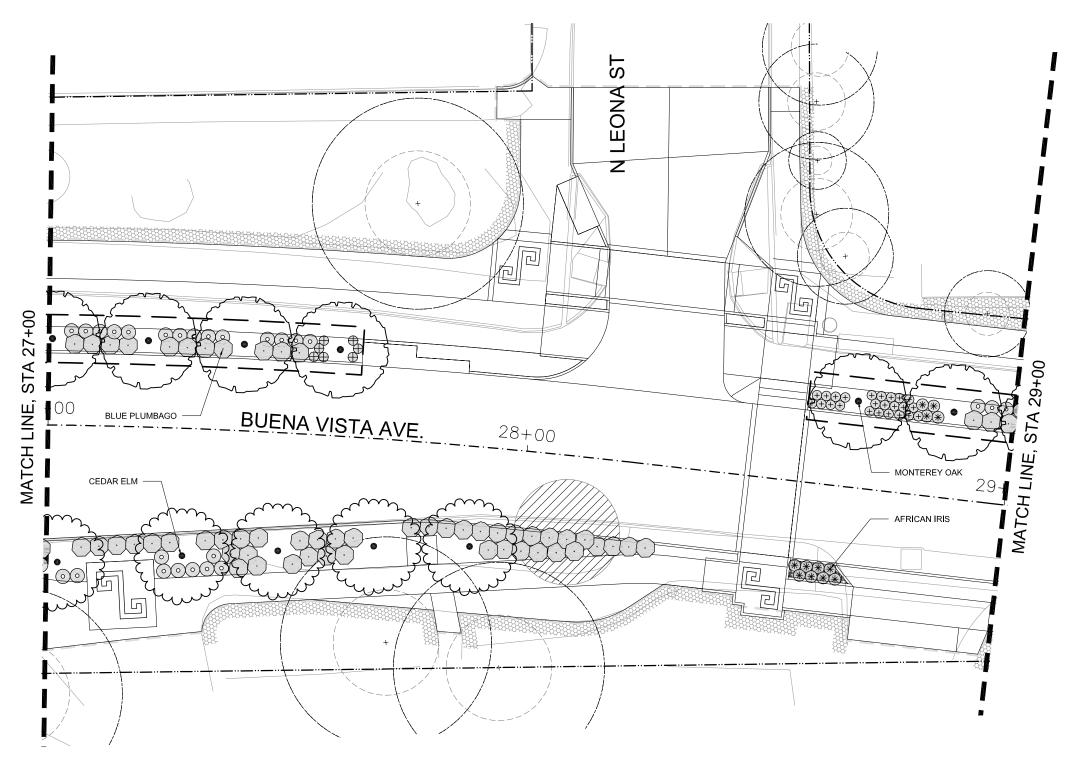
TREE PRESERVATION & PLANTING PLAN


STA 23+50 TO STA 24+75

SHEET 1 OF 16

DESIGN	CHECKED	DRAWN	PROJECT NO.	SUBMITTAL	SHEET NO
RD/AM	RD/AM	TM/RD	23-03763	70%	360



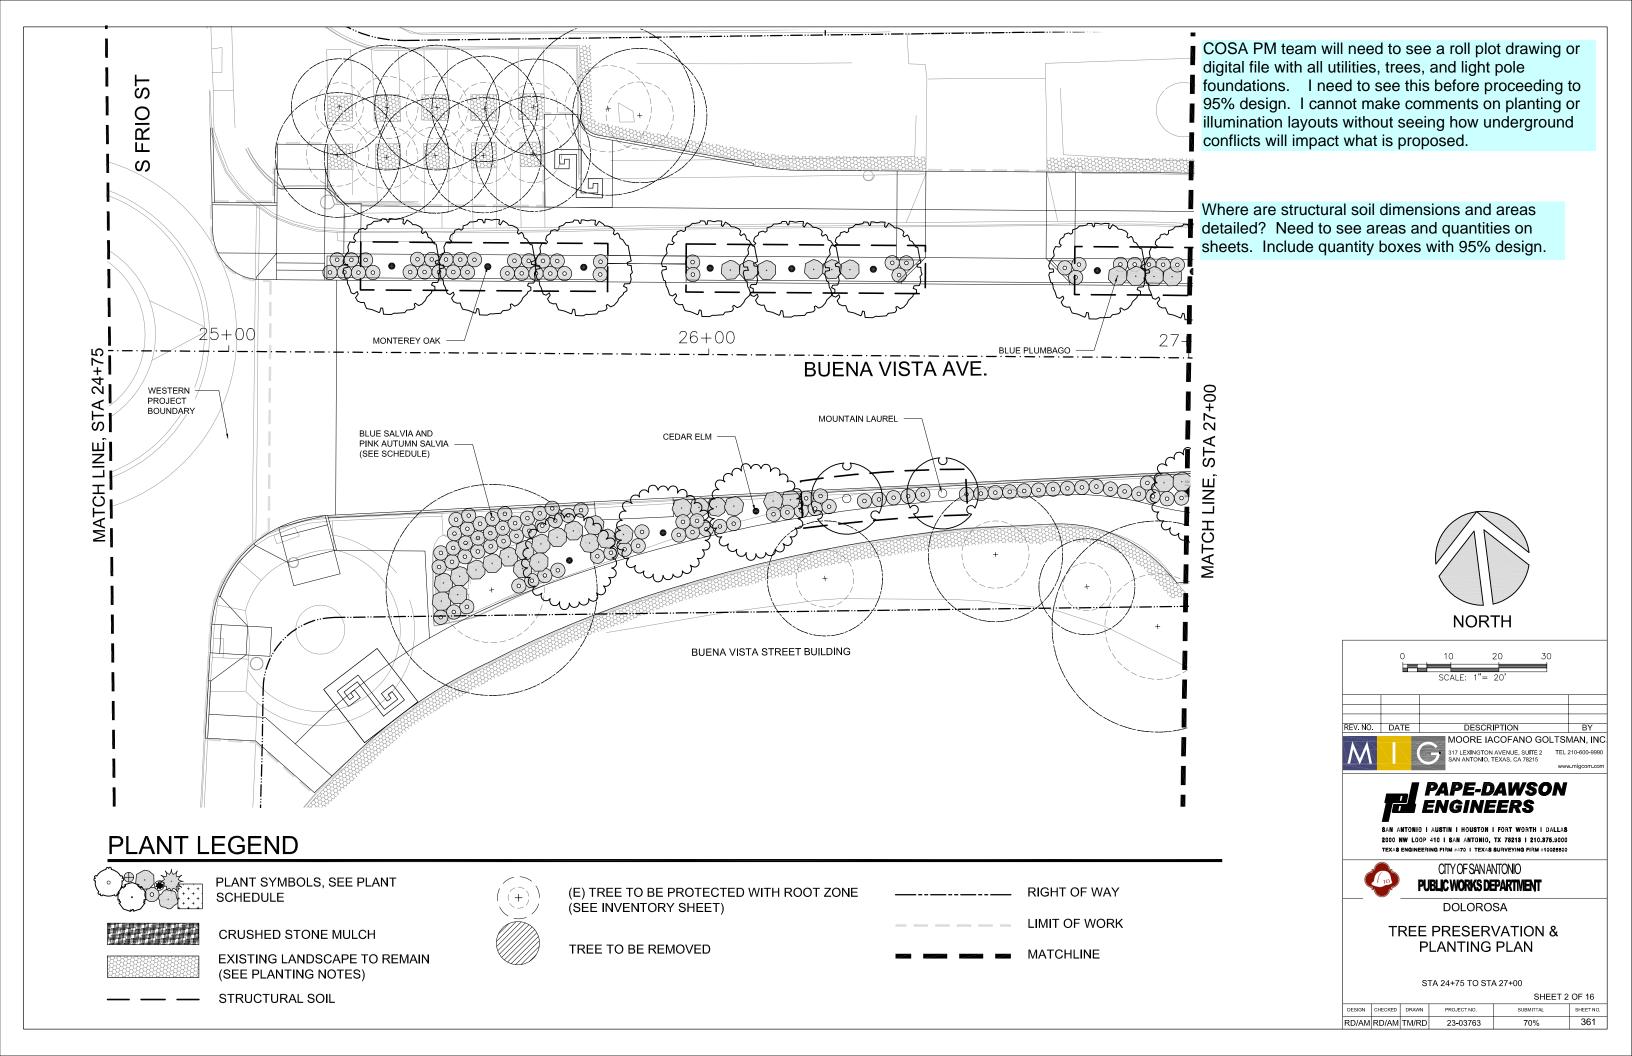

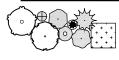

PLANT SYMBOLS, SEE PLANT SCHEDULE



CRUSHED STONE MULCH



EXISTING LANDSCAPE TO REMAIN (SEE PLANTING NOTES)

STRUCTURAL SOIL



(E) TREE TO BE PROTECTED WITH ROOT ZONE (SEE INVENTORY SHEET)

TREE TO BE REMOVED




RIGHT OF WAY LIMIT OF WORK



MATCHLINE



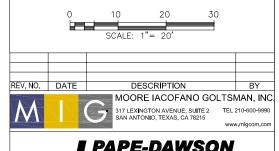



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CITY OF SAN ANTONIO PUBLIC WORKS DEPARTMENT


DOLOROSA


TREE PRESERVATION & PLANTING PLAN


STA 27+00 TO STA 29+00

SHEET 3 OF 16

RD/AM RD/AM TM/RD 23-03763 362

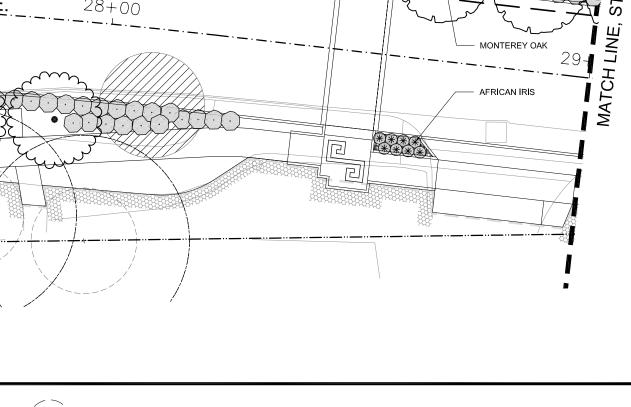

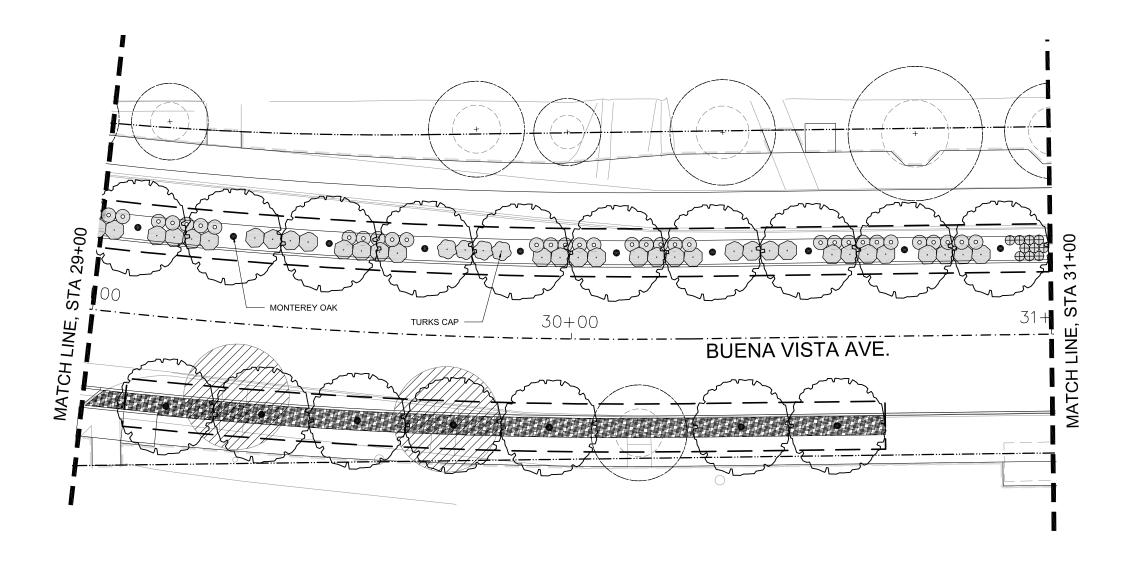

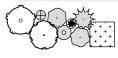

PLANT SYMBOLS, SEE PLANT SCHEDULE



CRUSHED STONE MULCH



EXISTING LANDSCAPE TO REMAIN (SEE PLANTING NOTES)

STRUCTURAL SOIL



(E) TREE TO BE PROTECTED WITH ROOT ZONE (SEE INVENTORY SHEET)



TREE TO BE REMOVED




RIGHT OF WAY

LIMIT OF WORK

MATCHLINE



# NORTH

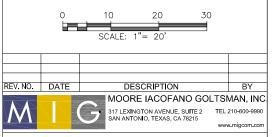



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CITYOFSANANTONIO PUBLIC WORKS DEPARTMENT


DOLOROSA


## TREE PRESERVATION & PLANTING PLAN

STA 29+00 TO STA 31+00

SHEET 4	OF 16
SUBMITTAL	SHEET NO

DESIGN	CHECKED	DRAWN	PROJECT NO.	SUBMITTAL	SHEET NO.
RD/AM	RD/AM	TM/RD	23-03763	70%	363

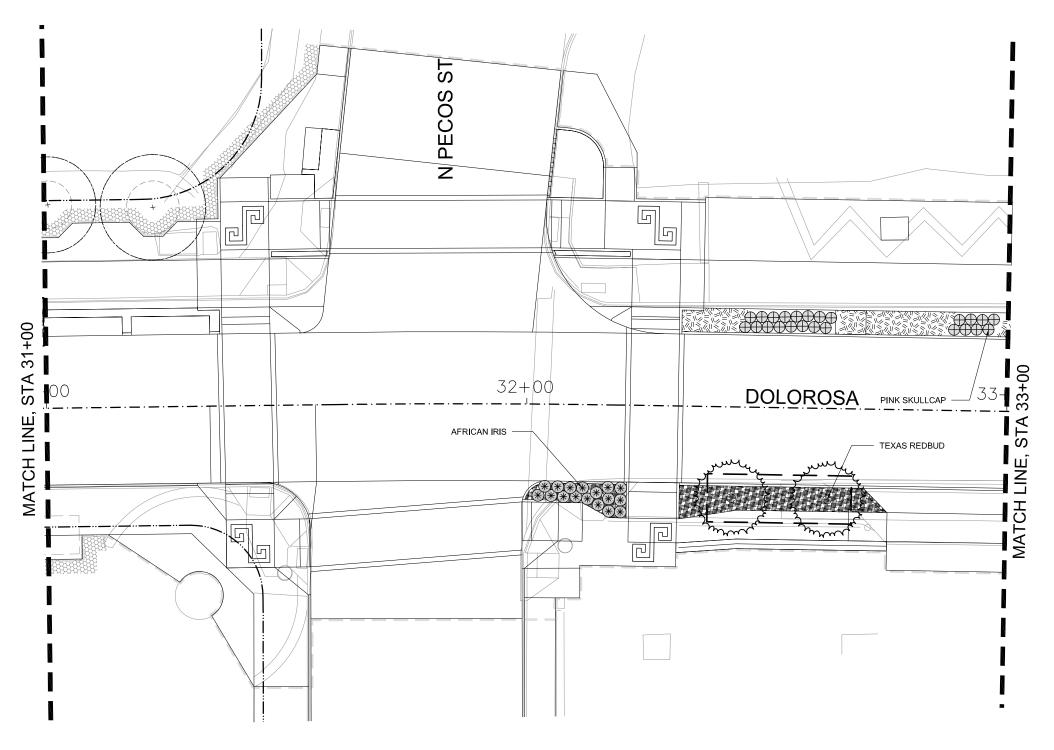


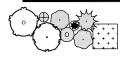

PLANT SYMBOLS, SEE PLANT SCHEDULE



CRUSHED STONE MULCH

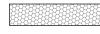


EXISTING LANDSCAPE TO REMAIN (SEE PLANTING NOTES)

STRUCTURAL SOIL



(E) TREE TO BE PROTECTED WITH ROOT ZONE (SEE INVENTORY SHEET)

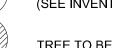


TREE TO BE REMOVED

\_\_\_\_\_ RIGHT OF WAY

— — — — LIMIT OF WORK

MATCHLINE



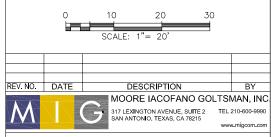



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CITY OF SAN ANTONIO
PUBLIC WORKS DEPARTMENT


DOLOROSA


TREE PRESERVATION & PLANTING PLAN

STA 31+00 TO STA 33+00

SHEET 5 OF 16
SUBMITTAL SHEET NO.

DESIGN	CHECKED	DRAWN	PROJECT NO.	SUBMITTAL	SHEET NO.
RD/AM	RD/AM	TM/RD	23-03763	70%	364

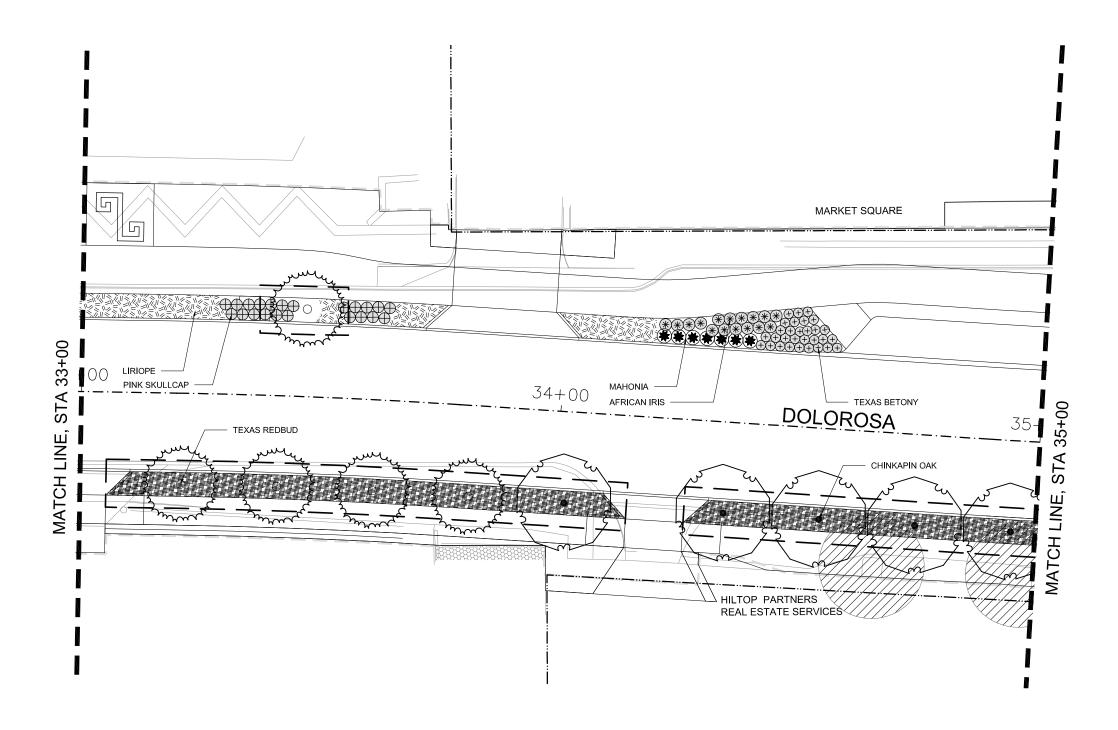

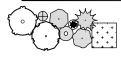

PLANT SYMBOLS, SEE PLANT SCHEDULE



CRUSHED STONE MULCH



EXISTING LANDSCAPE TO REMAIN (SEE PLANTING NOTES)


STRUCTURAL SOIL



(E) TREE TO BE PROTECTED WITH ROOT ZONE (SEE INVENTORY SHEET)




TREE TO BE REMOVED

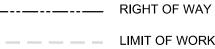

LIMIT OF WORK

MATCHLINE



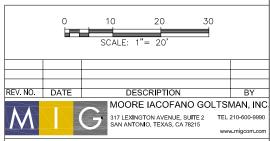



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CITY OF SAN ANTONIO PUBLIC WORKS DEPARTMENT


DOLOROSA


#### TREE PRESERVATION & PLANTING PLAN

STA 33+00 TO STA 35+00

SHEET 6 OF 16

DESIGN	CHECKED	DRAWN	PROJECT NO.	SUBMITTAL	SHEET NO.
RD/AM	RD/AM	TM/RD	23-03763	70%	365

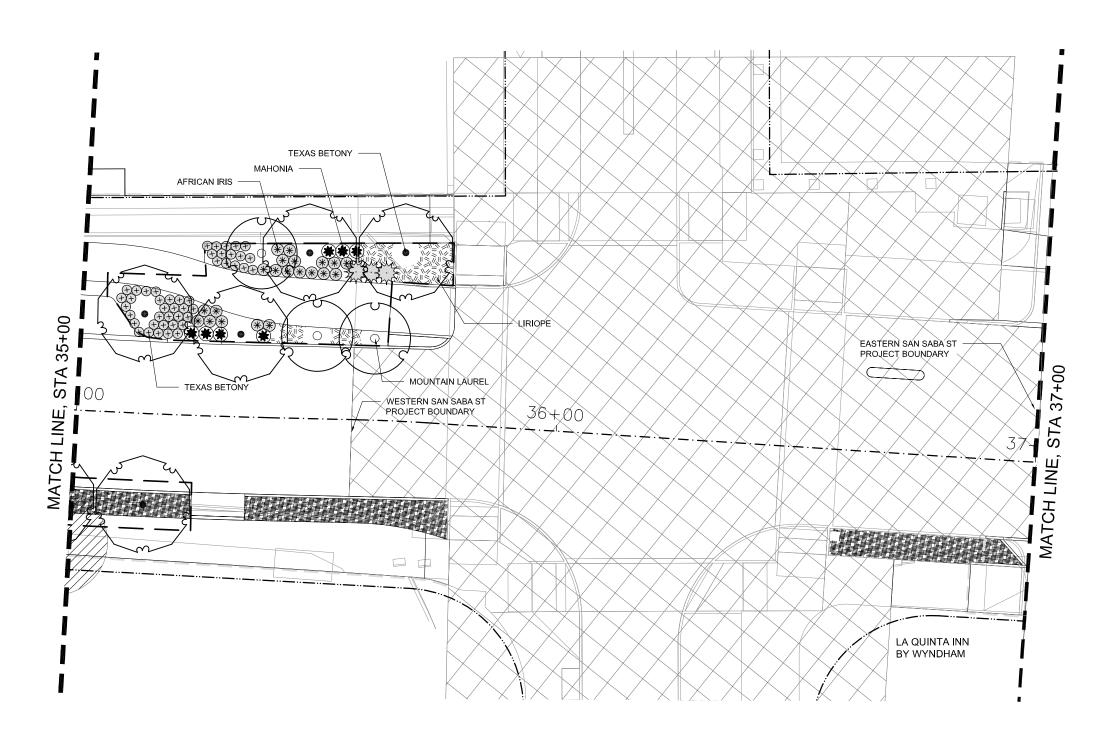

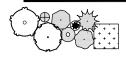

PLANT SYMBOLS, SEE PLANT SCHEDULE



CRUSHED STONE MULCH




EXISTING LANDSCAPE TO REMAIN (SEE PLANTING NOTES)

STRUCTURAL SOIL



(E) TREE TO BE PROTECTED WITH ROOT ZONE

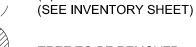


TREE TO BE REMOVED









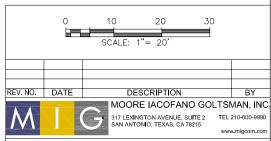



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CITY OF SAN ANTONIO PUBLIC WORKS DEPARTMENT


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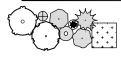
#### TREE PRESERVATION & PLANTING PLAN

STA 35+00 TO STA 37+00

SHEET 7	OF 16
SUBMITTAL	SHEET NO.

DESIGN	CHECKED	DRAWN	PROJECT NO.	SUBMITTAL	SHEET NO.
RD/AM	RD/AM	TM/RD	23-03763	70%	366



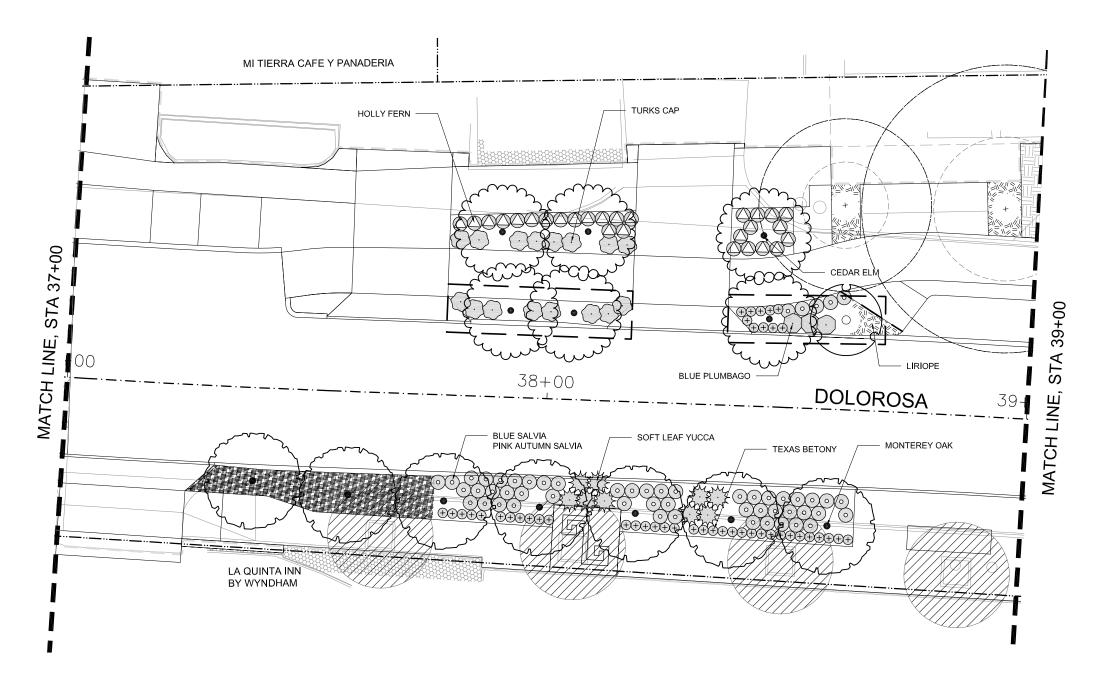

PLANT SYMBOLS, SEE PLANT SCHEDULE



CRUSHED STONE MULCH



EXISTING LANDSCAPE TO REMAIN (SEE PLANTING NOTES)

STRUCTURAL SOIL



(E) TREE TO BE PROTECTED WITH ROOT ZONE (SEE INVENTORY SHEET)



TREE TO BE REMOVED




LIMIT OF WORK

RIGHT OF WAY

MATCHLINE



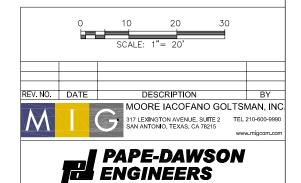



TEXAS ENGINEERING FIRM #470 | TEXAS SURVEYING FIRM #10028800



CITY OF SAN ANTONIO PUBLIC WORKS DEPARTMENT


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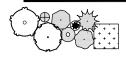
TREE PRESERVATION & PLANTING PLAN

STA 37+00 TO STA 39+00

SHEET 8 OF 16

DESIGN	CHECKED	DRAWN	PROJECT NO.	SUBMITTAL	SHEET NO.
RD/AM	RD/AM	TM/RD	23-03763	70%	367



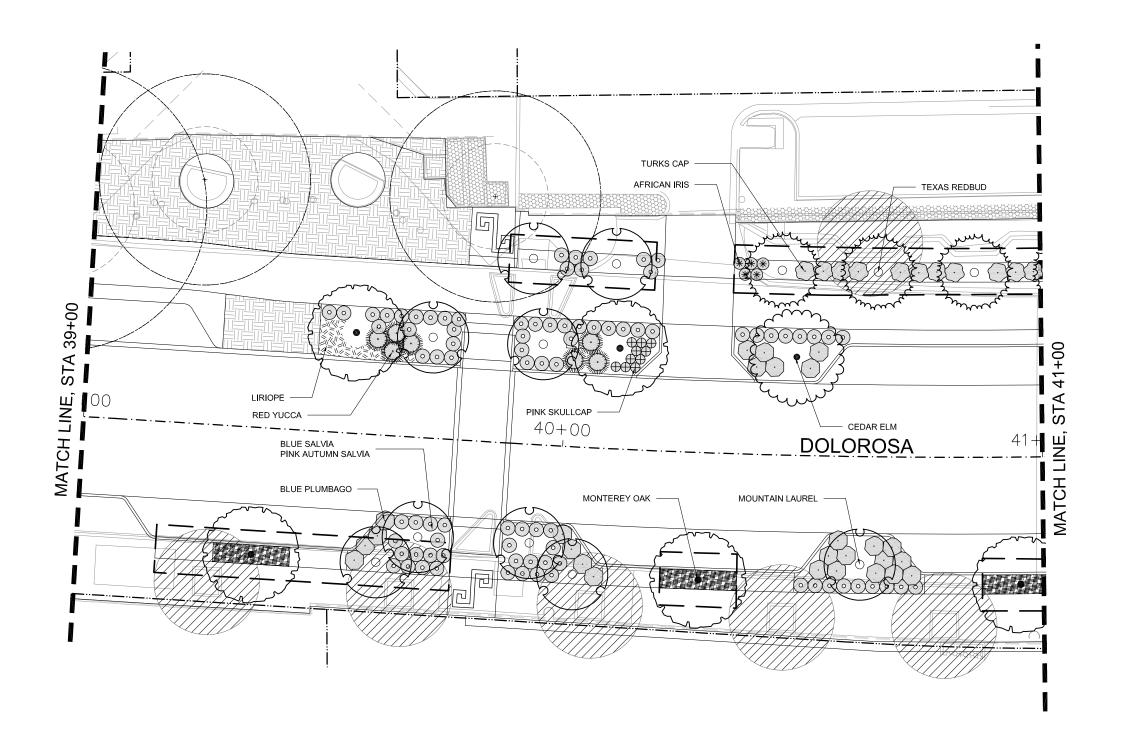

PLANT SYMBOLS, SEE PLANT SCHEDULE



CRUSHED STONE MULCH



EXISTING LANDSCAPE TO REMAIN (SEE PLANTING NOTES)


STRUCTURAL SOIL



(E) TREE TO BE PROTECTED WITH ROOT ZONE (SEE INVENTORY SHEET)




TREE TO BE REMOVED

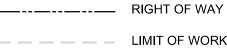

LIMIT OF WORK

MATCHLINE



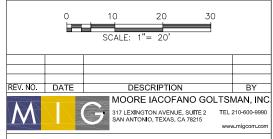



SAN ANTONIO I AUSTIN I HOUSTON I FORT WORTH I DALLAS 2000 NW LOOP 410 I SAN ANTONIO, TX 78213 I 210.375,9000 Texas engineering firm #470 I Texas surveying firm #10028800



CITY OF SAN ANTONIO PUBLIC WORKS DEPARTMENT


DOLOROSA


#### TREE PRESERVATION & PLANTING PLAN

STA 39+00 TO STA 41+00

STILL 13 ST 10					
DESIGN	CHECKED	DRAWN	PROJECT NO.	SUBMITTAL	SHEET NO.
RD/AM	RD/AM	TM/RD	23-03763	70%	368

SHEET 0 OF 16

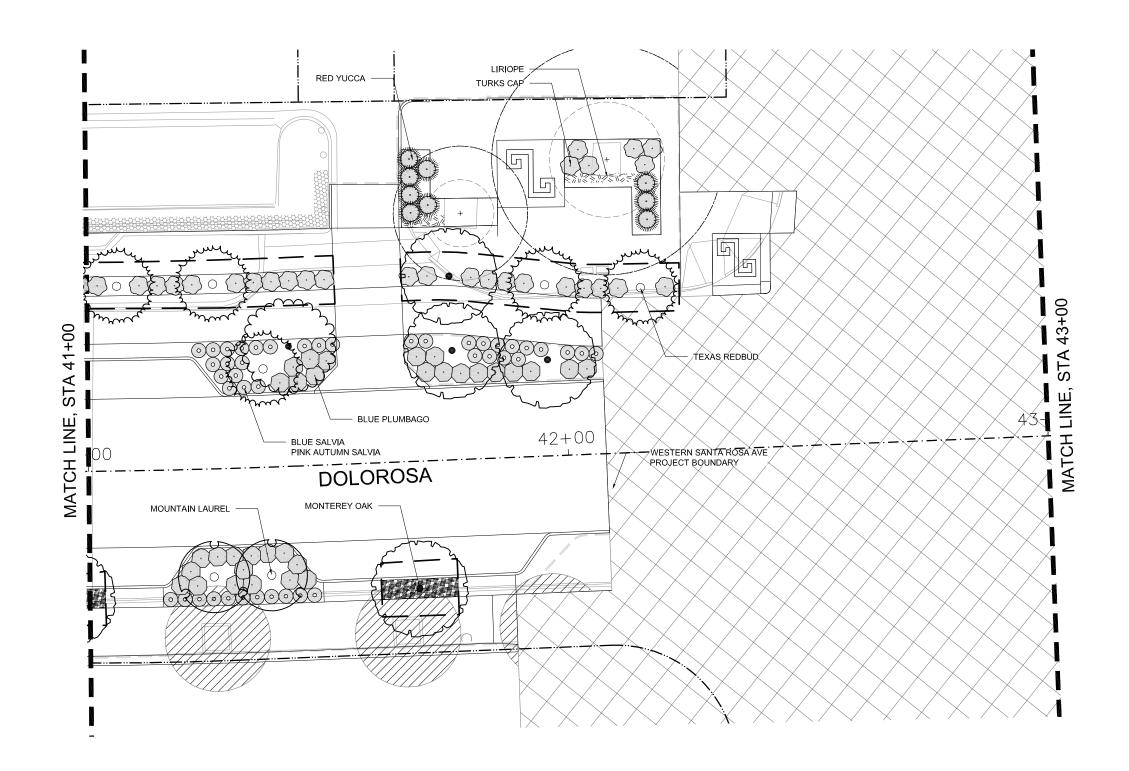

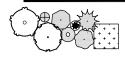

PLANT SYMBOLS, SEE PLANT SCHEDULE



CRUSHED STONE MULCH



EXISTING LANDSCAPE TO REMAIN (SEE PLANTING NOTES)

STRUCTURAL SOIL



(E) TREE TO BE PROTECTED WITH ROOT ZONE (SEE INVENTORY SHEET)




TREE TO BE REMOVED



LIMIT OF WORK

MATCHLINE



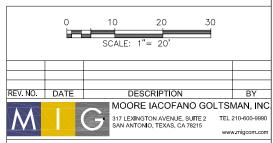



SAN ANTONIO I AUSTIN I HOUSTON I FORT WORTH I DALLAS 2000 NW LOOP 410 I SAN ANTONIO, TX 78213 I 210.376,9000 TEXAS ENGINEERING FIRM #470 I TEXAS SURVEYING FIRM #10028800




CITY OF SAN ANTONIO PUBLIC WORKS DEPARTMENT

DOLOROSA

TREE PRESERVATION & PLANTING PLAN

STA 41+00 TO STA 43+00

SHEET 10					0 OF 16
DESIGN	CHECKED	DRAWN	PROJECT NO.	SUBMITTAL	SHEET NO.
RD/AM	RD/AM	TM/RD	23-03763	70%	369

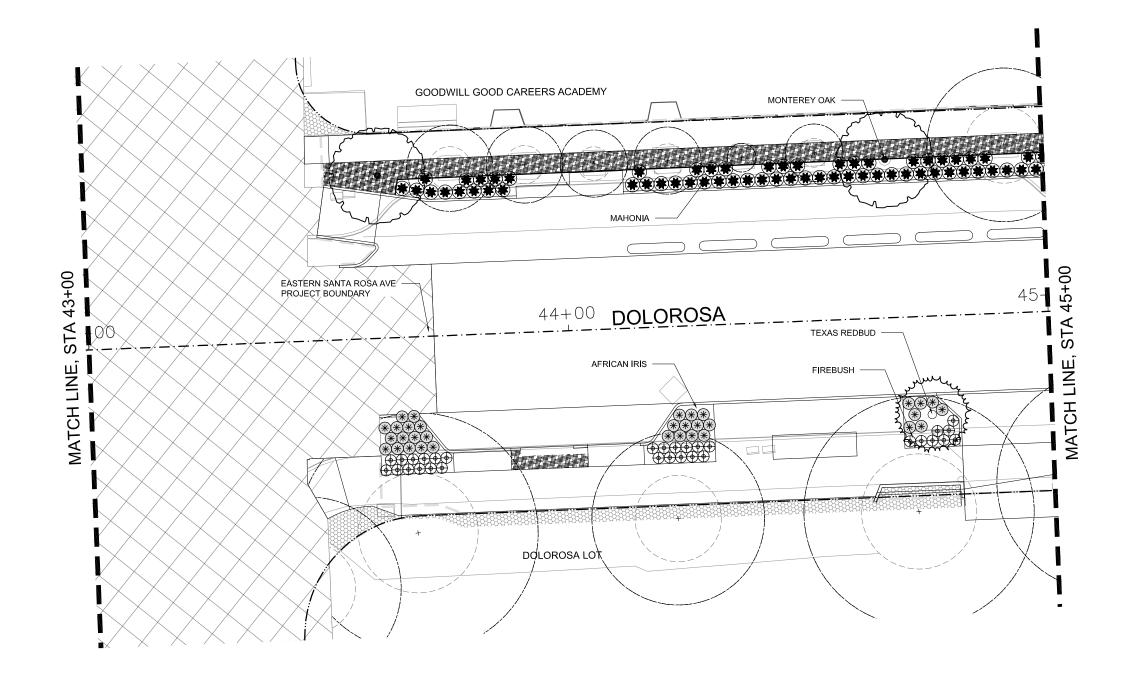



PLANT SYMBOLS, SEE PLANT SCHEDULE



CRUSHED STONE MULCH



EXISTING LANDSCAPE TO REMAIN (SEE PLANTING NOTES)

STRUCTURAL SOIL



(E) TREE TO BE PROTECTED WITH ROOT ZONE (SEE INVENTORY SHEET)




TREE TO BE REMOVED



MATCHLINE



# **NORTH**

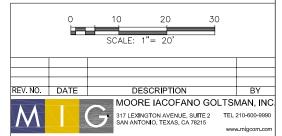



SAN ANTONIO I AUSTIN I HOUSTON I FORT WORTH I DALLAS 2000 NW LOOP 410 I SAN ANTONIO, TX 78213 I 218.375.9080 TEXAS ENGINEERING FIRM #470 | TEXAS SURVEYING FIRM #10026



CITY OF SAN ANTONIO PUBLIC WORKS DEPARTMENT


DOLOROSA


#### TREE PRESERVATION & PLANTING PLAN

STA 43+00 TO STA 45+00

JECT NO.	SUBMITTAL	SHEET NO.
	SHEET 1	1 OF 16

RD/AM RD/AM TM/RD 23-03763 370 70%

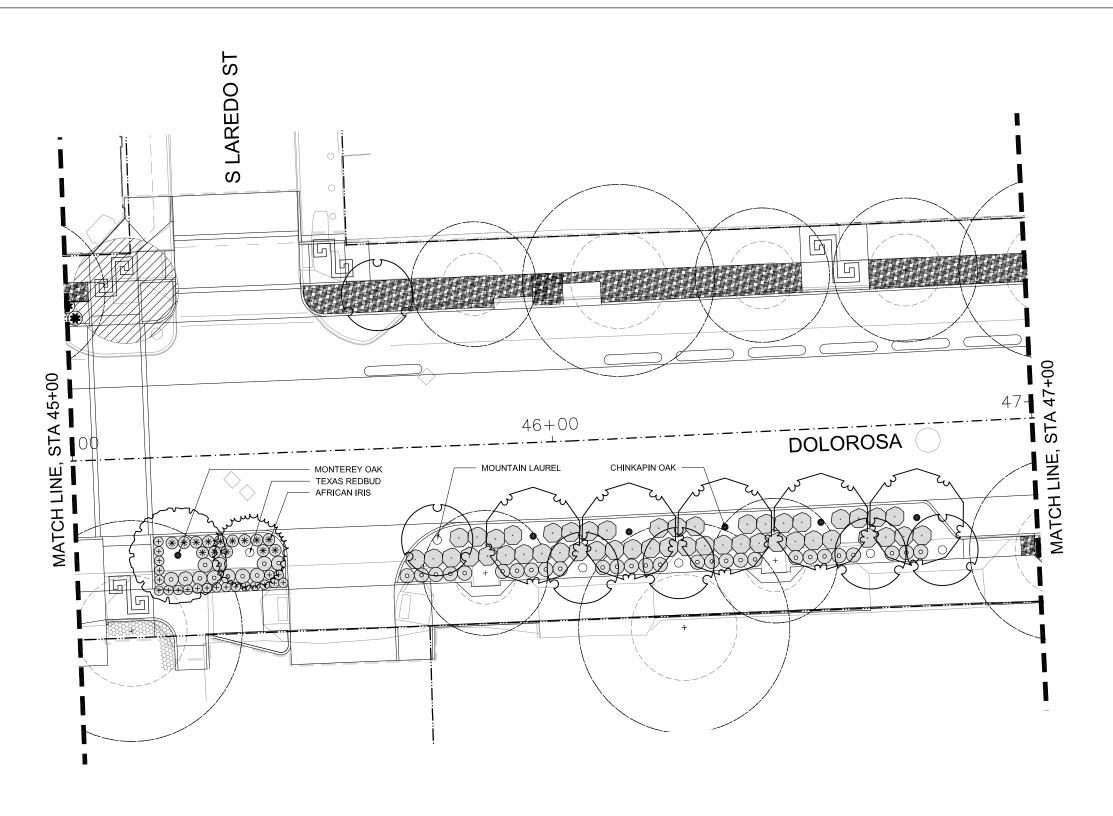

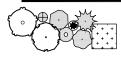

PLANT SYMBOLS, SEE PLANT SCHEDULE



CRUSHED STONE MULCH



EXISTING LANDSCAPE TO REMAIN (SEE PLANTING NOTES)

STRUCTURAL SOIL



(E) TREE TO BE PROTECTED WITH ROOT ZONE (SEE INVENTORY SHEET)




TREE TO BE REMOVED

RIGHT OF WAY

LIMIT OF WORK

MATCHLINE

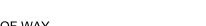



REV. NO. DATE

CITY OF SAN ANTONIO PUBLIC WORKS DEPARTMENT

PAPE-DAWSON ENGINEERS

SAN ANTONIO I AUSTIN I HOUSTON I FORT WORTH I DALLAS 2000 NW LOOP 410 I SAN ANTONIO, TX 78213 I 210.375,9000 Texas engineering firm #470 I Texas surveying firm #10028800

NORTH

DESCRIPTION


MOORE IACOFANO GOLTSMAN, INC 17 LEXINGTON AVENUE, SUITE 2 TEL 210-600-9990 AN ANTONIO, TEXAS, CA 78215


DOLOROSA

## TREE PRESERVATION & PLANTING PLAN

STA 45+00 TO STA 47+00

				SHEET I	2 OF 10
DESIGN	CHECKED	DRAWN	PROJECT NO.	SUBMITTAL	SHEET NO.
RD/AM	RD/AM	TM/RD	23-03763	70%	371

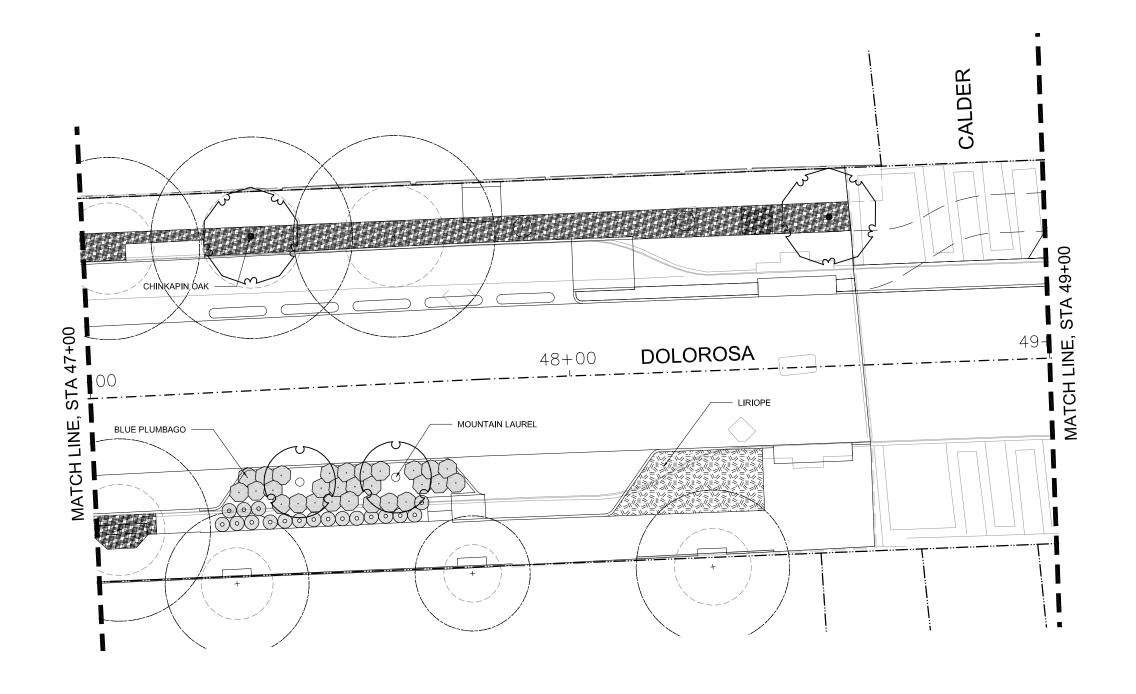

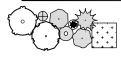

PLANT SYMBOLS, SEE PLANT SCHEDULE



CRUSHED STONE MULCH




EXISTING LANDSCAPE TO REMAIN (SEE PLANTING NOTES)


STRUCTURAL SOIL



(E) TREE TO BE PROTECTED WITH ROOT ZONE (SEE INVENTORY SHEET)

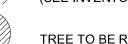

TREE TO BE REMOVED

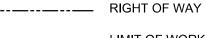

LIMIT OF WORK

MATCHLINE



REV. NO. DATE

CITYOFSANANTONIO PUBLIC WORKS DEPARTMENT

PAPE-DAWSON ENGINEERS

**NORTH** 

DESCRIPTION


MOORE IACOFANO GOLTSMAN, INC.


DOLOROSA

# TREE PRESERVATION & PLANTING PLAN

STA 47+00 TO STA 49+00

SHEELI					3 OF 10
DESIGN	CHECKED	DRAWN	PROJECT NO.	SUBMITTAL	SHEET NO.
RD/AM	RD/AM	TM/RD	23-03763	70%	372

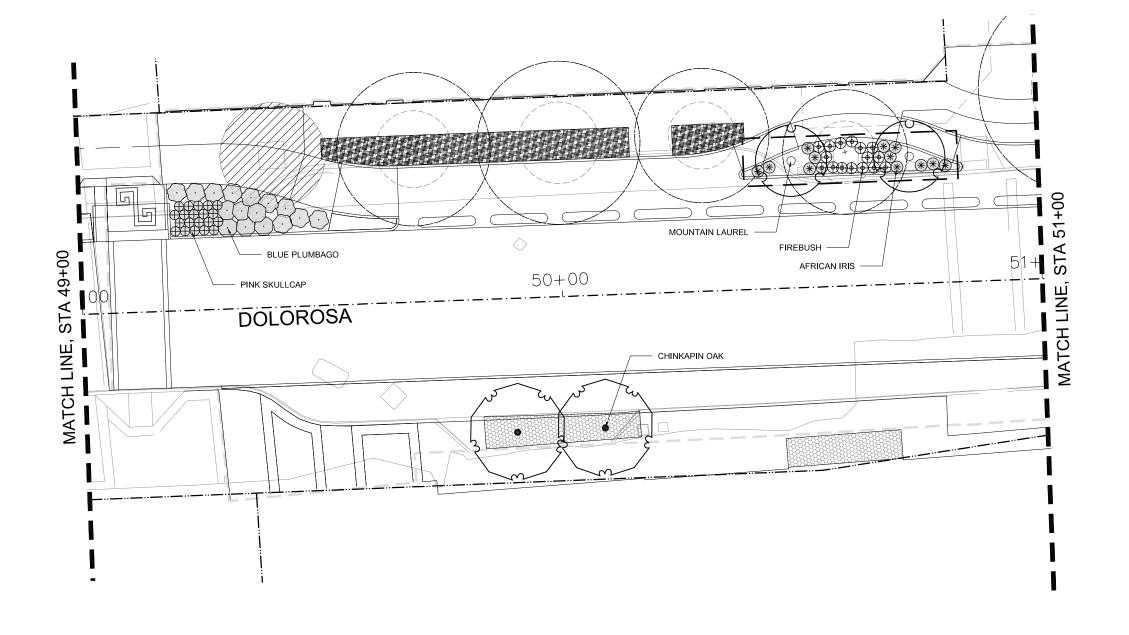

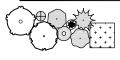

PLANT SYMBOLS, SEE PLANT SCHEDULE



CRUSHED STONE MULCH



EXISTING LANDSCAPE TO REMAIN (SEE PLANTING NOTES)

STRUCTURAL SOIL



(E) TREE TO BE PROTECTED WITH ROOT ZONE (SEE INVENTORY SHEET)



TREE TO BE REMOVED




RIGHT OF WAY

LIMIT OF WORK

MATCHLINE



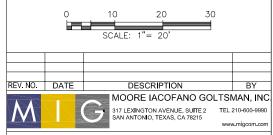



SAN ANTONIO I AUSTIN I HOUSTON I FORT WORTH I DALLAS 2000 NW LOOP 410 I SAN ANTONIO, TX 78213 I 210.375,9000 Texas engineering firm #470 I Texas surveying firm #10028800



CITY OF SAN ANTONIO PUBLIC WORKS DEPARTMENT

DOLOROSA


#### TREE PRESERVATION & PLANTING PLAN


STA 49+00 TO STA 51+00

AWN	PROJECT NO.	SUBMITTAL	SHEET NO.
		SHEET 1	4 OF 16

 DESIGN
 CHECKED
 DRAWN
 PROJECT NO.

 RD/AM
 RD/AM
 TM/RD
 23-03763

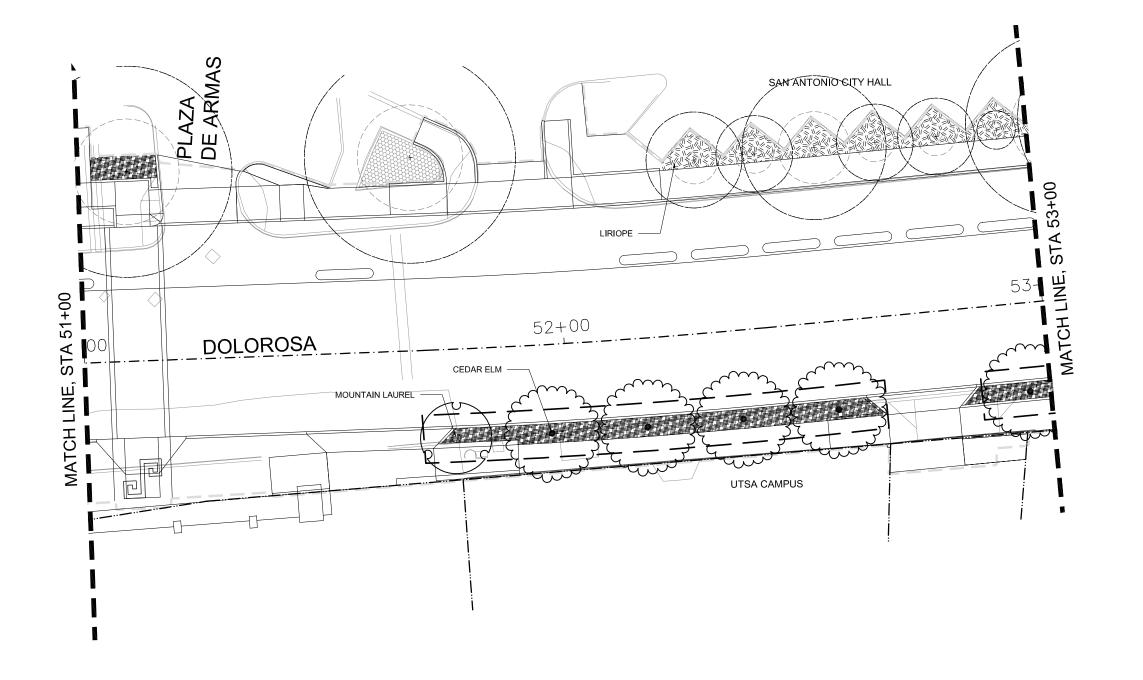

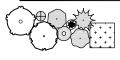

PLANT SYMBOLS, SEE PLANT SCHEDULE



CRUSHED STONE MULCH



EXISTING LANDSCAPE TO REMAIN (SEE PLANTING NOTES)

STRUCTURAL SOIL



(E) TREE TO BE PROTECTED WITH ROOT ZONE (SEE INVENTORY SHEET)



TREE TO BE REMOVED



LIMIT OF WORK

MATCHLINE



# REV. NO. DATE DESCRIPTION MOORE IACOFANO GOLTSMAN, INC . 17 LEXINGTON AVENUE, SUITE 2 TEL 210-600-9990 SAN ANTONIO, TEXAS, CA 78215



SAN ANTONIO I AUSTIN I HOUSTON I FORT WORTH I DALLAS 2000 NW LOOP 410 I SAN ANTONIO, TX 78213 I 210.375,9000 Texas engineering firm #470 I Texas surveying firm #10028800



CITY OF SAN ANTONIO PUBLIC WORKS DEPARTMENT


DOLOROSA


TREE PRESERVATION & PLANTING PLAN

STA 51+00 TO STA 53+00

SHEET 15 OF 16

DESIGN	CHECKED	DRAWN	PROJECT NO.	SUBMITTAL	SHEET NO.
RD/AM	RD/AM	TM/RD	23-03763	70%	374

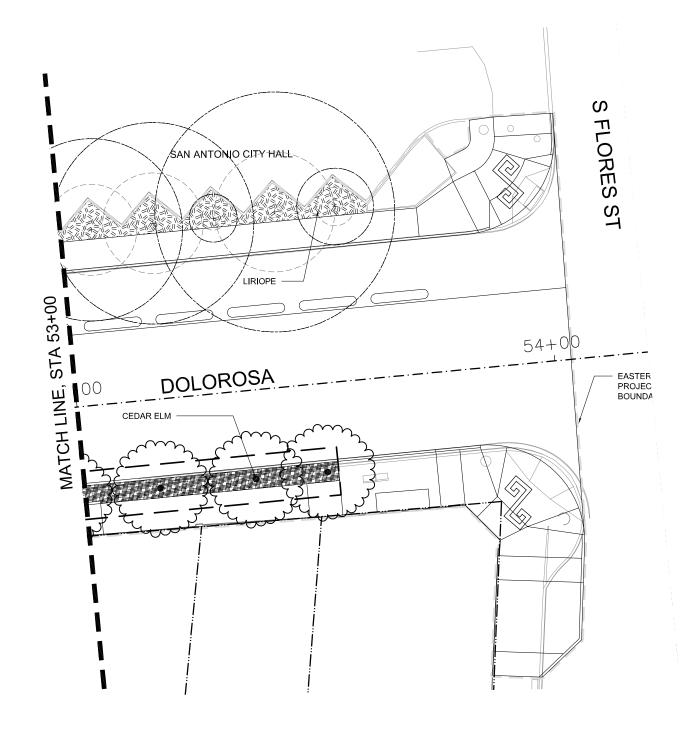

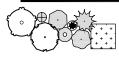

PLANT SYMBOLS, SEE PLANT SCHEDULE



CRUSHED STONE MULCH



EXISTING LANDSCAPE TO REMAIN (SEE PLANTING NOTES)

STRUCTURAL SOIL



(E) TREE TO BE PROTECTED WITH ROOT ZONE (SEE INVENTORY SHEET)



TREE TO BE REMOVED




\_ \_ \_ \_ LIMIT OF WORK



MATCHLINE



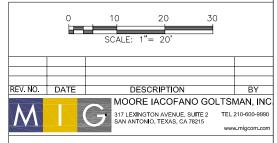



SAN ANTONIO I AUSTIN I HOUSTON I FORT WORTH I DALLAS 2000 NW LOOP 410 I SAN ANTONIO, TX 78213 I 210.375.9000 Texas engineering firm #470 I Texas Surveying firm #10028800




CITY OF SAN ANTONIO
PUBLIC WORKS DEPARTMENT

DOLOROSA

# TREE PRESERVATION & PLANTING PLAN

STA 53+00 TO STA 55+00

			SHEET 16 OF 16		
DESIGN	CHECKED	DRAWN	PROJECT NO.	SUBMITTAL	SHEET NO.
RD/AM	RD/AM	TM/RD	23-03763	70%	375

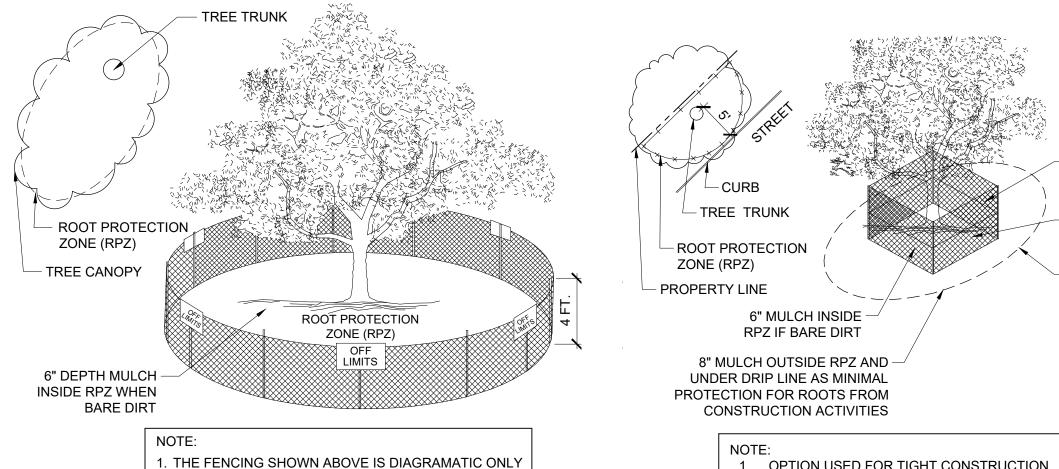

- THE FENCING SHOWN ABOVE IS DIAGRAMATIC ONLY AND WILL CONFORM TO THE DRIP LINE AND LIMITED TO PROJECT BOUNDARY.
- 2. FOR ACCEPTABLE FENCING MATERIALS SEE SPECIFICATIONS.

1. OPTION USED FOR TIGHT CONSTRUCTION AREAS OR WHEN CONSTRUCTION OCCURS IN ROOT PROTECTION ZONE.

ESTABLISH FENCE PROTECTION MIN.


ROOT PROTECTION

5' FROM TRUNK

ZONE (RPZ)


**DRIP LINE** 

2. SEE SPECIFICATIONS FOR ACCEPTABLE FENCING MATERIALS.

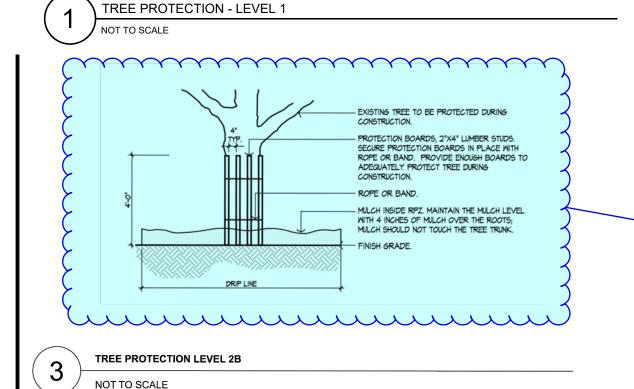

TREE PROTECTION - LEVEL 2

Blurry when zoomed. Ensure that this is digital linework and not an image.

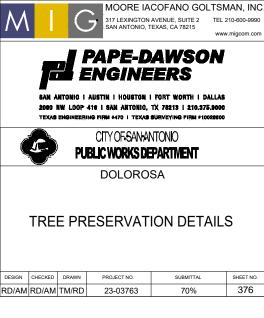


DESCRIPTION


REV. NO. DATE

TREES THAT ARE MARKED TO BE PRESERVED ON A SITE PLAN AND FOR WHICH UTILITIES MUST PASS TROUGH THEIR ROOT PROTECTION ZONES MAY REQUIRE TUNNELING AS OPPOSED TO OPEN TRENCHES. THE DECISION TO TUNNEL WILL BE DETERMINED ON A CASE BY CASE BASIS BY THE ENGINEER.

TUNNELS SHALL BE DUG THROUGH THE ROOT PROTECTION ZONE IN ORDER TO MINIMIZE ROOT DAMAGE.

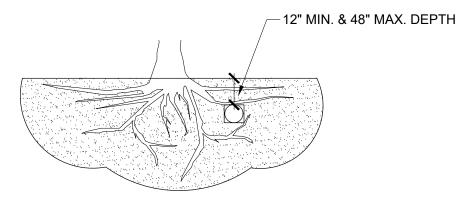


TUNNEL TO MINIMIZE ROOT DAMAGE (TOP) AS OPPOSED TO SURFACE-DUG TRENCHES IN ROOT PROTECTION ZONE WHEN THE 5' MINIMUM DISTANCE FROM TRUNK CANNOT BE ACHIEVED.

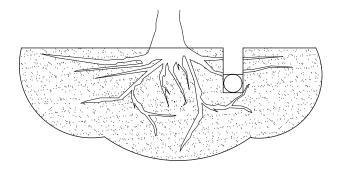

OPEN TRENCHING MAY BE USED IF EXPOSED TREE ROOTS DO NOT EXCEED 3" OR ROOTS CAN BE BENT BACK.



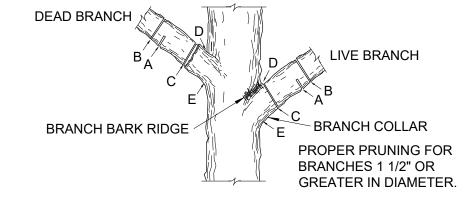


NOTE: DO NOT CUT FROM D TO E.

- 1. FIRST CUT TO PREVENT THE BARK FROM BEING PEELED WHEN THE BRANCH FALLS.
- 2. SECOND CUT TO REDUCE THE WEIGHT OF BRANCH.
- 3. FINAL CUT ALLOW FOR HEALING COLLAR BUT NO STUBS
- 4. BRANCH RIDGES INDENT PROPERLY BRANCH RIDGES, WHICH ARE SITES FOR DECAY.

<u>FOR OAKS ONLY:</u> PAINT ALL WOUNDS OR CUTS WITH PRUNING PAINT WITHIN 20 MIN. TO PREVENT THE SPREAD OF OAK WILT.





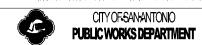


DOLOROSA

TREE PRESERVATION DETAILS

DESIGN	CHECKED	DRAWN	PROJECT NO.	SUBMITTAL	SHEET NO.
RD/AM	RD/AM	TM/RD	23-03763	70%	377

TREE PRESERVATION INVENTORY TO BE ADDED IN 95% SUBMITTAL

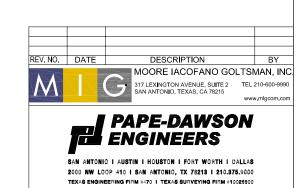



DOLOROSA

TREE PRESERVATION INVENTORY

DESIGN	CHECKED	DRAWN	PROJECT NO.	SUBMITTAL	SHEET N
RD/AM	RD/AM	TM/RD	23-03763	70%	378

# **GENERAL NOTES**

- CONTRACTOR SHALL FAMILIARIZE HIMSELF WITH EXISTING SITE CONDITIONS AND REVIEW ALL RELATED DRAWINGS AND SPECIFICATIONS PRIOR TO BID.
- THE DRAWINGS ARE DIAGRAMMATIC. CONTRACTOR SHALL VERIFY FIELD CONDITIONS AND DETERMINE CONDUIT ROUTING AND EXACT LOCATIONS OF EQUIPMENT AND DEVICES. NOTIFY THE ENGINEER IF THE APPROXIMATE CONDUIT ROUTING SHOWN ON PLANS IS NOT FEASIBLE. CONTRACTOR SHALL NOTIFY ENGINEER OF ANY CONFLICTS PRIOR TO ROUGH-IN.
- LOCATIONS OF DEVICES ARE DIAGRAMMATIC. EXACT LOCATIONS SHALL BE DETERMINED IN THE FIELD. CONTRACTOR SHALL NOTIFY ENGINEER OF ANY CONFLICTS PRIOR TO ROUGH-IN.
- ALL ELECTRICAL WORK SHALL BE IN ACCORDANCE WITH THE CURRENT ISSUE OF THE NATIONAL ELECTRIC CODE AND ALL APPLICABLE LOCAL CODES. ALL WORK SHALL MATCH THE EXISTING BUILDING'S ELECTRICAL INSTALLATION. ALL SYSTEMS SHALL BE INSTALLED IN A WORKMANLIKE MANNER IN ACCORDANCE WITH APPLICABLE STANDARDS AND SPECIFICATIONS APPROVED BY ALL AUTHORITIES HAVING JURISDICTION.
- PROVIDE A TYPED PANEL DIRECTORY FOR EACH NEW OR MODIFIED ELECTRICAL PANEL. DIRECTORY SHALL IDENTIFY THE CIRCUIT NUMBER, DEVICES SERVED, AND LOCATION OF DEVICES BY ROOM NUMBER. FILE COPY OF DIRECTORIES WITH THE OWNER'S REPRESENTATIVE WHEN WORK IS COMPLETED, AND PROVIDE COPIES WITH THE OWNER'S MANUALS.
- F. INDICATED SPARE AND/OR SPACES IN ALL EQUIPMENT ON THE ELECTRICAL ONE-LINE DIAGRAM AND IN THE PANEL SCHEDULES ARE THE MINIMUM NUMBER REQUIRED FOR THIS PROJECT.
- UNLESS OTHERWISE NOTED ELECTRICAL INSTALLATION SHALL MEET TXDOT ELECTRICAL STANDARDS.
- REFERENCE TXDOT DRAWING 'ELECTRICAL DETAILS CONDUITS & NOTES ED(1)-14 FOR ADDITIONAL MATERIALS AND INSTALLATION REQUIREMENTS.
- REFERENCE TXDOT DRAWING 'ELECTRICAL DETAILS CONDUCTORS ED(3)-14 FOR ADDITIONAL MATERIALS AND INSTALLATION REQUIREMENTS.
- REFERENCE TXDOT DRAWING 'ELECTRICAL DETAILS GROUND BOXES ED(4)-14 FOR ADDITIONAL MATERIALS AND INSTALLATION REQUIREMENTS.
- CONTRACTOR TO CALL 1800-DIG-TESS FOR MARKING OF ALL UNDERGROUND UTILITIES BEFORE PROCEEDING TO BEGIN ANY TRENCHING.

# LIGHTING GENERAL NOTES

- ELECTRICAL DRAWINGS INDICATE GENERAL LOCATIONS OF LIGHTING FIXTURES REFER TO LANDSCAPE DRAWINGS FOR COORDINATION AND LOCATIONS. IF THERE IS A DIFFERENCE IN QUANTITY OF FIXTURES SHOWN ON THE ARCHITECTURAL AND ELECTRICAL DRAWINGS, THEY SHALL USE THE GREATER QUANTITY FOR BIDDING AND CONTACT THE DESIGN TEAM FOR FINAL RESOLUTION.
- COORDINATE REMOVAL OF CPS ENERGY MAINTAINED ROADWAY LIGHTING WITH CPS ENERGY REPRESENTATIVE.


# POWER GENERAL NOTES

- A. REFERENCE EQUIPMENT LIGHTING PLANS FOR REQUIREMENTS AND ADDITIONAL INFORMATION OF TAGGED EQUIPMENT SHOWN ON PLAN.
- RECEPTACLES SHALL BE TAMPER PROOF, GFCI TYPE. PROVIDE "WHILE IN-USE", NEMA 3R, NON METALLIC COVERS FOR EXTERIOR RECEPTACLES EQUAL TO HUBBELL TAYMAC #ML45G.
- C. ALL RECEPTACLES SHALL BE COMMERCIAL SPECIFICATION GRADE UNLESS NOTED OTHERWISE.

#### **ABBREVIATION** DESCRIPTION

BREAIVION	DESCRIPTION
Α	AMPERE(S)
ABV	ABOVE
AIC	AMPERE INTERRUPTING CAPACITY
AHJ	AUTHORITY HAVING JURISDICTION
C	CONDUIT
CB	CIRCUIT BREAKER CIRCUIT
CKT COND	CONDUCTOR
CU	COPPER
DIA	DIAMETER
EC	ELECTRICAL CONTRACTOR
EMT	ELEC. METALLIC TUBING
EXIST	EXISTING
FT	FEET, FOOT
GALV	GALVANIZED
GC	GENERAL CONTRACTOR
GFCI	GROUND FAULT CIRCUIT INTERRUPTER
GND	GROUND
HOA ID	HAND OFF AUTOMATIC INSIDE DIAMETER
IMC	INTERMEDIATE STEEL CONDUIT
IN	INCHES
JB	JUNCTION BOX
KV	KILOVOLT
KVA	KILOVOLT AMPERE
KW LED	KILOWATT LIGHT EMITTING DIODE
LGT	LIGHTING DIODE
M	MANHOLE
MCB	MAIN CIRCUIT BREAKER
MAX	MAXIMUM
MIN MLO	MINIMUM MAIN LUGS ONLY
MTG	MOUNTING
N/A	NOT APPLICABLE
NC NEO	NORMALLY CLOSED
NEC NFPA	NATIONAL ELECTRICAL CODE NATIONAL FIRE PROTECTION ASSOCIATION
NF	NON FUSED
N.O.	NORMALLY OPEN
N.T.S.	NOT-TO-SCALE
N, NEMA	NEMA=NATIONAL ELECTRICAL MANUFACTURERS
	ASSOCIATION
OC	ON CENTER
OFCI	OWNER FURNISHED CONTRACTOR INSTALLED
OH P	OVERHEAD POLE
PNL	PANELBOARD
PSI	POUNDS PER SQUARE INCH
PVC	POLY VINYL CHLORIDE CONDUIT
PWR	POWER
RGS	RIGID GALVANIZED STEEL CONDUIT
RMC	RIGID METAL CONDUIT
SF	SQUARE FEET,FOOT
SPD	SURGE PROTECTIVE DEVICE
SQ	SQUARE
SW	SWITCH
TYP. UEB	TYPICAL UNDERGROUND ELECTRIC BRANCH CIRCUIT
U.N.O.	UNLESS NOTED OTHERWISE
٧	VOLT(S)
W	WIRE `
WP	WEATHERPROOF
Z	IMPEDANCE
1P 2P	ONE POLE
2P 3P	TWO POLE THREE POLE
Ø	PHASE
<i>-</i>	

# SYMBOL DESCRIPTION

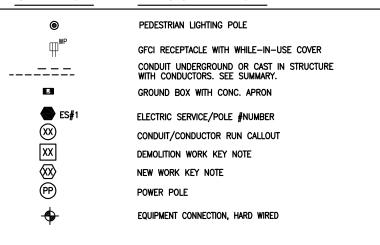

INTERIM REVIEW DOCUMENT INCOMPLETE. NOT INTENDED FOR PERMIT, BIDDING OR CONSTRUCTION.
FNGINFER: TRAVIS E. WILTSHIR ENGINEER: \_\_\_ P.E. SERIAL NO: 85219 COMPANY NAME: CNG ENGINEERING, PLLC COMPANY REG. NO. F-7964
01-20-202

REV. NO. DATE DESCRIPTION **CNG ENGINEERING** 



1917 N NEW BRAUNFELS AVE, SUITE 201 SAN ANTONIO, TEXAS 78208 TBPE FIRM # F-7964



SAN ANTONIO I AUSTIN I HOUSTON I FORT WORTH I DALLAS 2000 NW LOOP 410 I SAN ANTONIO, TX 78213 I 210,375,9000 TEXAS ENGINEERING FIRM #470 | TEXAS SURVEYING FIRM #1002680





CITY OF SAN ANTONIO PUBLIC WORKS DEPARTMENT


DOLOROSA

ELECTRICAL SYMBOLS & **ABBREVIATIONS** 

1						
	DESIGN	CHECKED	DRAWN	PROJECT NO.	SUBMITTAL	SHEET NO.
	JC	JC	CDC	23-03763	70%	379
						0.0

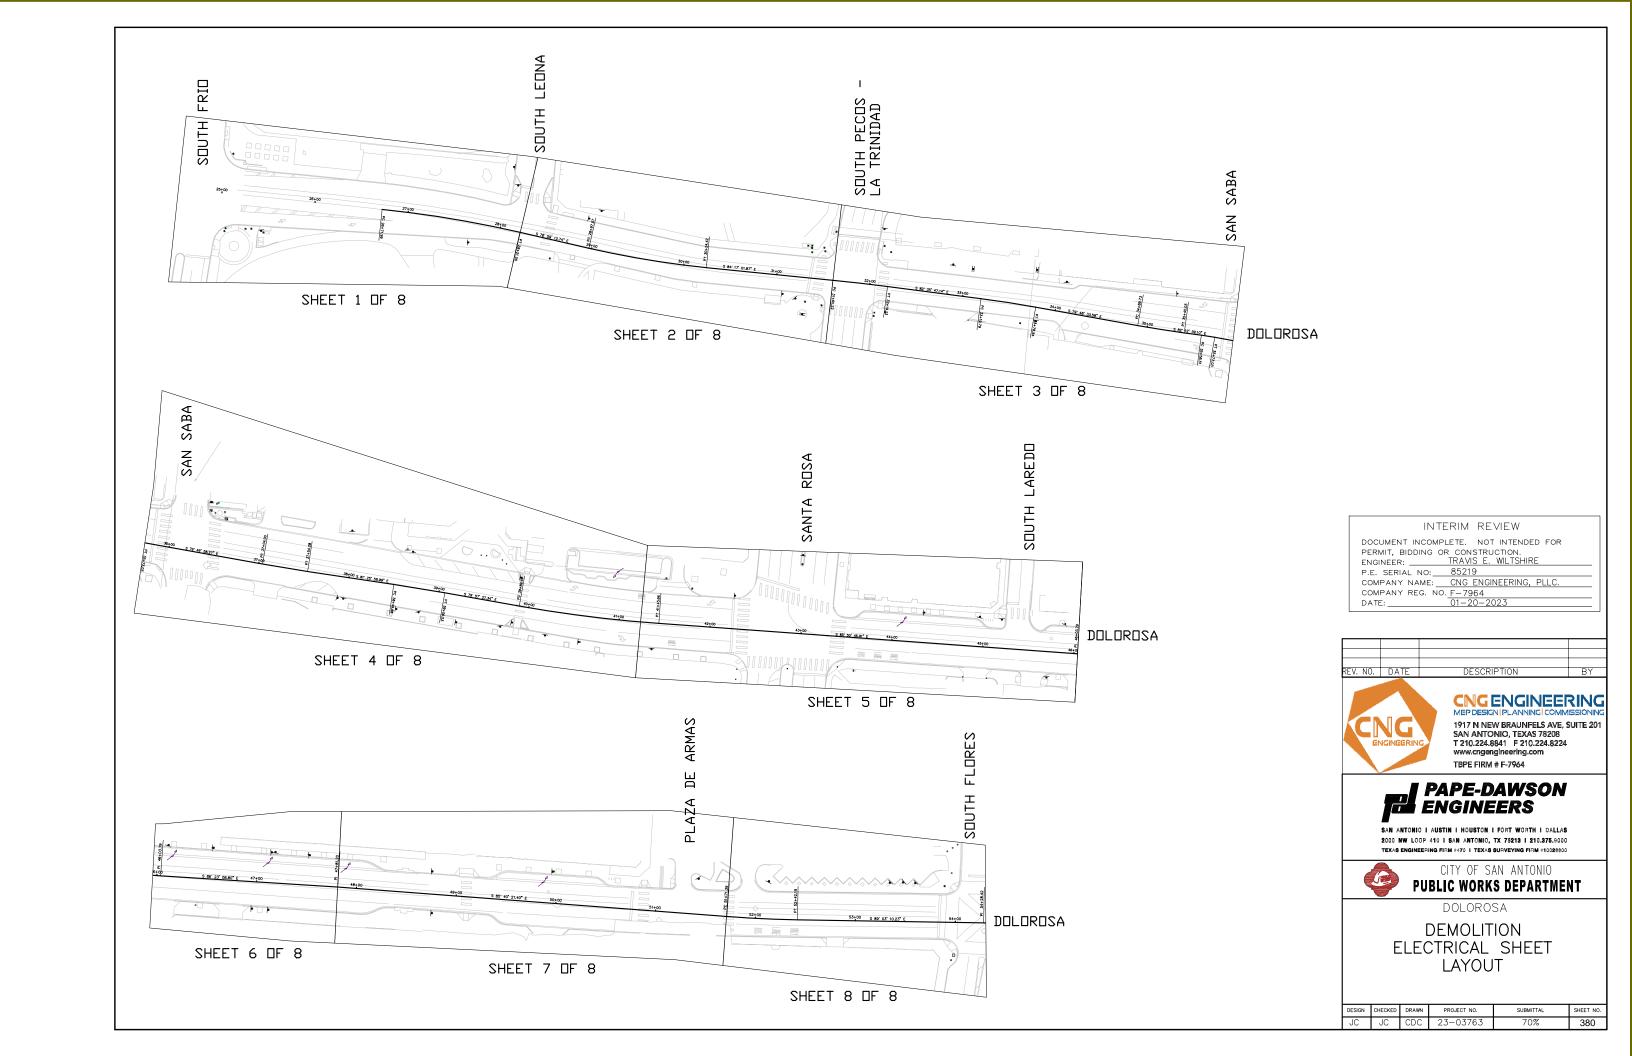

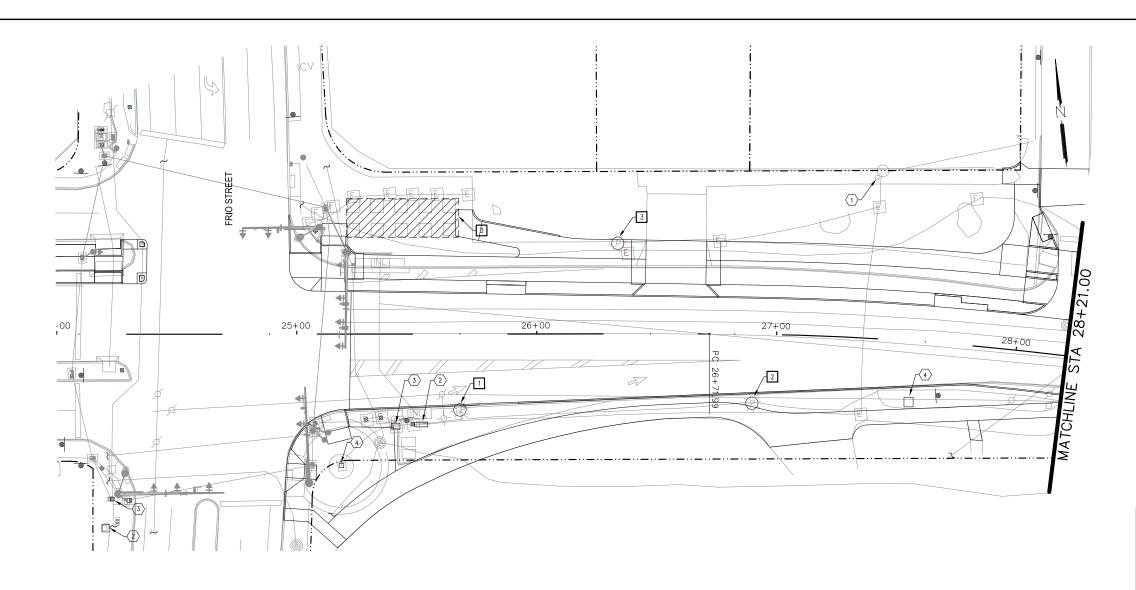

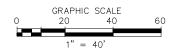

# ⟨#⟩ KEYED NOTES: (THIS SHEET ONLY)

- 1. EXISTING CPS ENERGY ELECTRICAL EQUIPMENT TO REMAIN.
- 2. EXISTING METER CABINET TO REMAIN.
- 3. EXISTING METER PEDESTAL TO REMAIN.
- EXISTING CITY OWNED DIGITAL DISPLAY TO REMAIN.
- EXISTING UNIVERSITY STONE COLUMN PEDESTRIAN LIGHT TO REMAIN.

# # DEMO KEYED NOTES: (THIS SHEET ONLY)

- REMOVE CITY OWNED LUMINAIRE AND ASSOCIATED CONDUCTORS AND RETURN TO OWNER.
- 2. EXISTING CPSE STREET LIGHT FIXTURE TO BE REMOVED AND RELOCATED BY CPS ENERGY. COORDINATE REMOVAL WITH CPS ENERGY.
- 3. REMOVE DAMAGED WIRING AND DEVICES FROM TREE WELLS AND RETURN TO OWNER.

## **GENERAL NOTES:**

- 1. CONTRACTOR TO COORDINATE WITH CPS ENERGY FOR REMOVAL AND RELOCATION OF CPSE EQUIPMENT.
- 2. PROTECT EXISTING TO REMAIN ELECTRICAL EQUIPMENT AND UNDERGROUND CIRCUITS. REPAIR AND RELOCATE AS NECESSARY TO MAINTAIN OPERATION. ADJUST ASSOCIATED IN-GRADE ELECTRICAL JUNCTION BOX COVER PLATES TO NEW ELEVATION. PROVIDE BOX EXTENSION AS
- 3. REFER TO TRAFFIC SIGNAL DRAWINGS FOR TRAFFIC SIGNAL SCOPE OF WORK.

#### INTERIM REVIEW

DOCUMENT INCOMPLETE. NOT INTENDED FOR

PERMIT, BIDDING OR CONSTRUCTION.
ENGINEER: TRAVIS E. WILTSHIR

ENGINEER: TRAVIS E. WILTSHIRE
P.E. SERIAL NO: 85219
COMPANY NAME: CNG ENGINEERING, PLLC 

EV. NO. DATE DESCRIPTION CNG ENGINEERING MEP DESIGN PLANNING COMMISSIONING





1917 N NEW BRAUNFELS AVE, SUITE 201

SAN ANTONIO I AUSTIN I HOUSTON I FORT WORTH I DALLAS 2000 NW LOOP 410 I SAN ANTONIO, TX 78213 I 210.375.9000 TEXAS ENGINEERING FIRM #470 | TEXAS SURVEYING FIRM #10028800



CITY OF SAN ANTONIO PUBLIC WORKS DEPARTMENT


DOLOROSA


# **DEMOLITION ELECTRICAL PLANS**

STA START TO STA 28+21.00

				JIILLI I	01 0
DESIGN	CHECKED	DRAWN	PROJECT NO.	SUBMITTAL	SHEET NO.
JC	JC	CDC	23-03763	70%	381

NECESSARY.

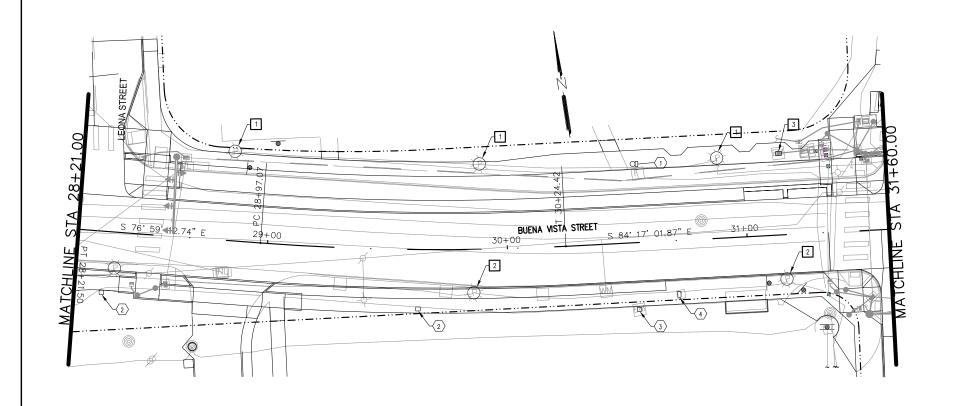

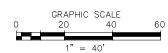

# (#) KEYED NOTES: (THIS SHEET ONLY)

- 1. EXISTING TELECOMMUNICATIONS POLE AND CPS ENERGY ELECTRICAL METERED EQUIPMENT TO REMAIN.
- 2. EXISTING UNIVERSITY STONE COLUMN PEDESTRIAN LIGHT TO REMAIN.
- 3. EXISTING METER PEDESTAL TO REMAIN.
- 4. EXISTING CITY OWNED DIGITAL DISPLAY TO REMAIN.

# # DEMO KEYED NOTES: (THIS SHEET ONLY)

- REMOVE CITY OWNED LUMINAIRE AND ASSOCIATED CONDUCTORS AND RETURN TO OWNER.
- 2. EXISTING CPSE STREET LIGHT FIXTURE TO BE REMOVED AND RELOCATED BY CPS ENERGY. COORDINATE REMOVAL WITH CPS ENERGY.
- TRAFFIC SIGNAL METER PEDESTAL TO BE RELOCATED. COORDINATE RELOCATION OF EQUIPMENT WITH CPS ENERGY.

#### **GENERAL NOTES:**

- 1. CONTRACTOR TO COORDINATE WITH CPS ENERGY FOR REMOVAL AND RELOCATION OF CPSE EQUIPMENT.
- 2. PROTECT EXISTING TO REMAIN ELECTRICAL EQUIPMENT AND UNDERGROUND CIRCUITS. REPAIR AND RELOCATE AS NECESSARY TO MAINTAIN OPERATION. ADJUST ASSOCIATED IN-GRADE ELECTRICAL JUNCTION BOX COVER PLATES TO NEW ELEVATION. PROVIDE BOX EXTENSION AS NECESSARY.
- 3. REFER TO TRAFFIC SIGNAL DRAWINGS FOR TRAFFIC SIGNAL SCOPE OF WORK.

#### INTERIM REVIEW

DOCUMENT INCOMPLETE. NOT INTENDED FOR PERMIT, BIDDING OR CONSTRUCTION.
FNGINFFR: TRAVIS E. WILTSHIRE

ENGINEER: TRAVIS E. WILTSHIRE
P.E. SERIAL NO: 85219
COMPANY NAME: CNG ENGINEERING, PLLC COMPANY NAME. 01.0 2.1.... COMPANY REG. NO. F-7964 DATE: 01-20-202

EV. NO. DATE DESCRIPTION CNG ENGINEERING MEP DESIGN PLANNING COMMISSIONING



1917 N NEW BRAUNFELS AVE, SUITE 201 SAN ANTONIO, TEXAS 78208 T 210.224.8841 F 210.224.8224 TBPE FIRM # F-7964



SAN ANTONIO I AUSTIN I HOUSTON I FORT WORTH I DALLAS 2000 NW LOOP 410 | SAN ANTONIO, TX 78213 | 210.375.9000 TEXAS ENGINEERING FIRM #470 | TEXAS SURVEYING FIRM #10028800



CITY OF SAN ANTONIO **PUBLIC WORKS DEPARTMENT** 


DOLOROSA


# **DEMOLITION** ELECTRICAL PLANS

STA 28+22.00 TO STA 31+60.00

SHEET 2 OF 8

				OI 122 1 =	o, <b>o</b>
DESIGN	CHECKED	DRAWN	PROJECT NO.	SUBMITTAL	SHEET NO.
JC	JC	CDC	23-03763	70%	382

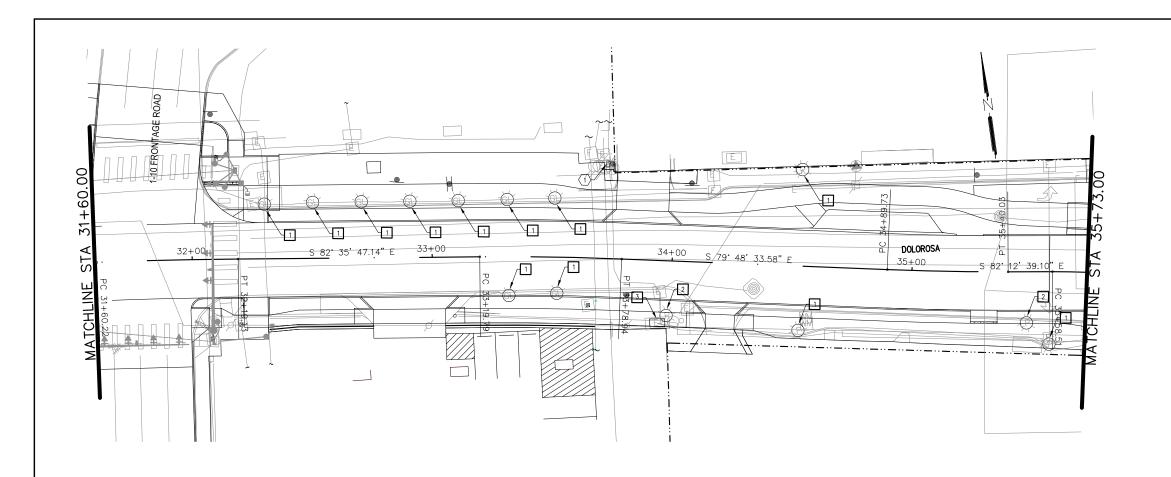

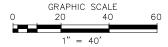

# #> KEYED NOTES: (THIS SHEET ONLY)

1. EXISTING METER EQUIPMENT TO REMAIN.

# # DEMO KEYED NOTES: (THIS SHEET ONLY)

- 1. REMOVE CITY OWNED LUMINAIRE AND ASSOCIATED CONDUCTORS AND RETURN TO OWNER.
- 2. EXISTING CPSE STREET LIGHT FIXTURE TO BE REMOVED AND RELOCATED BY CPS ENERGY. COORDINATE REMOVAL WITH CPS ENERGY.
- 3. EXISTING PEDESTRIAN METER AND DISTRIBUTION CABINET TO BE RELOCATED AND UPGRADED. COORDINATE RELOCATION WITH CPS ENERGY.

#### **GENERAL NOTES:**

- 1. CONTRACTOR TO COORDINATE WITH CPS ENERGY FOR REMOVAL AND RELOCATION OF CPSE EQUIPMENT.
- 2. PROTECT EXISTING TO REMAIN ELECTRICAL EQUIPMENT AND UNDERGROUND CIRCUITS. REPAIR AND RELOCATE AS NECESSARY TO MAINTAIN OPERATION. ADJUST ASSOCIATED IN-GRADE ELECTRICAL JUNCTION BOX COVER PLATES TO NEW ELEVATION. PROVIDE BOX EXTENSION AS NECESSARY.
- 3. REFER TO TRAFFIC SIGNAL DRAWINGS FOR TRAFFIC SIGNAL SCOPE OF WORK.

#### INTERIM REVIEW

DOCUMENT INCOMPLETE. NOT INTENDED FOR PERMIT, BIDDING OR CONSTRUCTION.
ENGINEER: TRAVIS E. WILTSHIRE

ENGINEER: TRAVIS E. WILTSHIRE
P.E. SERIAL NO: 85219
COMPANY NAME: CNG ENGINEERING, PLLC

COMPANY REG. NO. F-7964
DATE: 01-20-202



1917 N NEW BRAUNFELS AVE, SUITE 201 SAN ANTONIO, TEXAS 78208 T 210.224.8841 F 210.224.8224 TBPE FIRM # F-7964



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CITY OF SAN ANTONIO **PUBLIC WORKS DEPARTMENT** 


DOLOROSA

# **DEMOLITION** ELECTRICAL PLANS

STA 31+60.00 TO STA 53+73.00

SHEET 3 OF 8

				SHEET	01 0
DESIGN	CHECKED	DRAWN	PROJECT NO.	SUBMITTAL	SHEET NO.
JC	JC	CDC	23-03763	70%	383

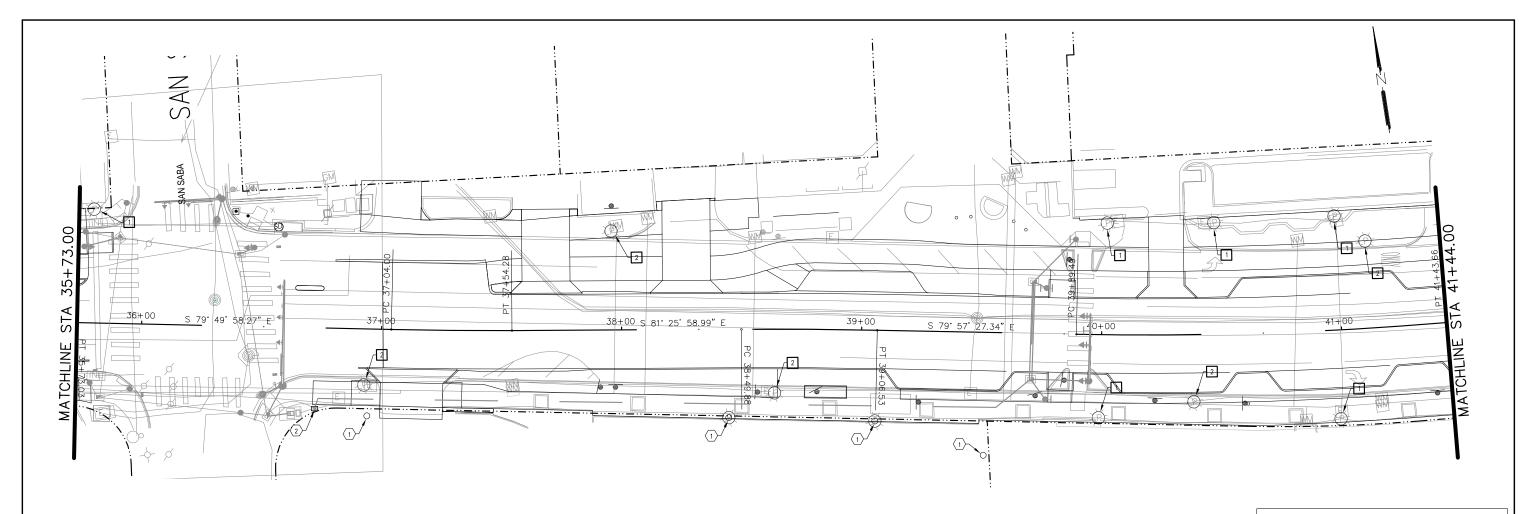

# ⟨#⟩ KEYED NOTES: (THIS SHEET ONLY)

- 1. PEDESTRIAN POLE LIGHTS LOCATED ON LA QUINTA PROPERTY. REMOVAL WILL REQUIRE APPROVAL BY LA QUINTA PROPERTY OWNER.
- 2. ELECTRICAL METERED SERVICE NO. 3, 936
  DOLOROSA ST. (INSTALLED AS PART OF SAN
  SABA ROAD RENOVATIONS) PROTECT DURING
  CONSTRUCTION

# # DEMO KEYED NOTES: (THIS SHEET ONLY)

- 1. REMOVE CITY OWNED LUMINAIRE AND ASSOCIATED CONDUCTORS AND RETURN TO OWNER.
- 2. EXISTING CPSE STREET LIGHT FIXTURE TO BE REMOVED AND RELOCATED BY CPS ENERGY. COORDINATE REMOVAL WITH CPS ENERGY.

## GENERAL NOTES:

- 1. CONTRACTOR TO COORDINATE WITH CPS ENERGY FOR REMOVAL AND RELOCATION OF CPSE EQUIPMENT.
- 2. PROTECT EXISTING TO REMAIN ELECTRICAL EQUIPMENT AND UNDERGROUND CIRCUITS. REPAIR AND RELOCATE AS NECESSARY TO MAINTAIN OPERATION. ADJUST ASSOCIATED IN-GRADE ELECTRICAL JUNCTION BOX COVER PLATES TO NEW ELEVATION. PROVIDE BOX EXTENSION AS NECESSARY.
- 3. REFER TO TRAFFIC SIGNAL DRAWINGS FOR TRAFFIC SIGNAL SCOPE OF WORK.

#### INTERIM REVIEW

DOCUMENT INCOMPLETE. NOT INTENDED FOR PERMIT, BIDDING OR CONSTRUCTION.
FNGINFFR: TRAVIS E. WILTSHIRE

ENGINEER: TRAVIS E. WILTSHIRE
P.E. SERIAL NO: 85219
COMPANY NAME: CNG ENGINEERING, PLLC.

COMPANY NAME: CNG ENGINEERING, PLLC COMPANY REG. NO. F-7964 01-20-2023

REV. NO. DATE DESCRIPTION BY



CNGENGINEERING
MEP DESIGNI PLANNING COMMISSIONING
1917 N NEW BRAUNFELS AVE, SUITE 201
SAN ANTONIO, TEXAS 78208
T 210.224.8841 F 210.224.8224
www.engengineering.com
TBPE FIRM # F-7964

PAPE-DAWSON ENGINEERS

SAN ANTONIO I AUSTIN I HOUSTON I FORT WORTH I DALLAS 2000 NW LOOP 410 I SAN ANTONIO, TX 78213 I 210,375,9000 Texas engineering firm #470 I Texas Surveying firm #10028800



CITY OF SAN ANTONIO
PUBLIC WORKS DEPARTMENT


DOLOROSA


# DEMOLITION ELECTRICAL PLANS

STA 53+73.00 TO STA 41+44.00

SHEET 4 OF 8

				SHEET T	01 0
DESIGN	CHECKED	DRAWN	PROJECT NO.	SUBMITTAL	SHEET NO.
JC	JC	CDC	23-03763	70%	384

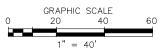

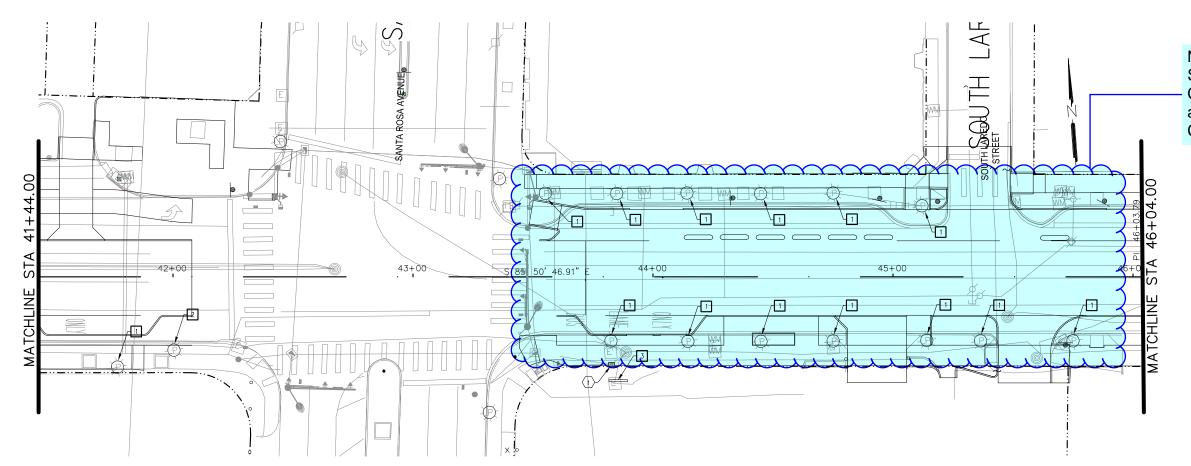

No ped poles salvaged east of Santa Rosa. Several of these are CPS hockey puck style luminaires and will need to be removed by CPS. Review and revise.

## GRAPHIC SCALE 0 20 40 60 1" = 40'

# (#) KEYED NOTES: (THIS SHEET ONLY)

1. ELECTRICAL METERED SERVICE NO. 4, 720
DOLOROSA ST. (INSTALLED AS PART OF SANTA ROSA
ROAD RENOVATIONS)

# # DEMO KEYED NOTES: (THIS SHEET ONLY)

- 1. REMOVE CITY OWNED LUMINAIRE AND ASSOCIATED CONDUCTORS AND RETURN TO OWNER.
- 2. EXISTING CPSE STREET LIGHT FIXTURE TO BE REMOVED AND RELOCATED BY CPS ENERGY. COORDINATE REMOVAL WITH CPS ENERGY.
- 3. COORDINATE REMOVAL OF RACK MOUNTED PEDESTRIAN LIGHTING ELECTRICAL SERVICE AND EQUIPMENT WITH CPS ENERGY.

#### **GENERAL NOTES:**

- 1. CONTRACTOR TO COORDINATE WITH CPS ENERGY FOR REMOVAL AND RELOCATION OF CPSE EQUIPMENT.
- 2. PROTECT EXISTING TO REMAIN ELECTRICAL EQUIPMENT AND UNDERGROUND CIRCUITS. REPAIR AND RELOCATE AS NECESSARY TO MAINTAIN OPERATION. ADJUST ASSOCIATED IN-GRADE ELECTRICAL JUNCTION BOX COVER PLATES TO NEW ELEVATION. PROVIDE BOX EXTENSION AS NECESSARY.
- 3. REFER TO TRAFFIC SIGNAL DRAWINGS FOR TRAFFIC SIGNAL SCOPE OF WORK.

#### INTERIM REVIEW

DOCUMENT INCOMPLETE. NOT INTENDED FOR PERMIT, BIDDING OR CONSTRUCTION.
ENGINEER: TRAVIS E. WILTSHIRE

P.E. SERIAL NO: 85219

COMPANY NAME: CNG ENGINEERING, PLLC.
COMPANY REG. NO. F-7964

DATE: 01-20-2023





CNGENGINEERING
MEP DESIGN I PLANNING I COMMISSIONING
1917 N NEW BRAUNFELS AVE, SUITE 201
SAN ANTONIO, TEXAS 78208
T 210.224.8841 F 210.224.8224
www.engengineering.com
TBPE FIRM # F-7964



SAN ANTONIO I AUSTIN I HOUSTON I FORT WORTH I DALLAS 2000 NW LOOP 410 I SAN ANTONIO, TX 78213 I 210.375,9000 Texas engineering firm #470 I Texas Surveying firm #10028800



CITY OF SAN ANTONIO
PUBLIC WORKS DEPARTMENT


DOLOROSA

# DEMOLITION ELECTRICAL PLANS


STA 41+44.00 TO STA 46+04.00

SHEET 5 OF 8

				OFFILE 1	o, <b>o</b>
DESIGN	CHECKED	DRAWN	PROJECT NO.	SUBMITTAL	SHEET NO.
JC	JC	CDC	23-03763	70%	385

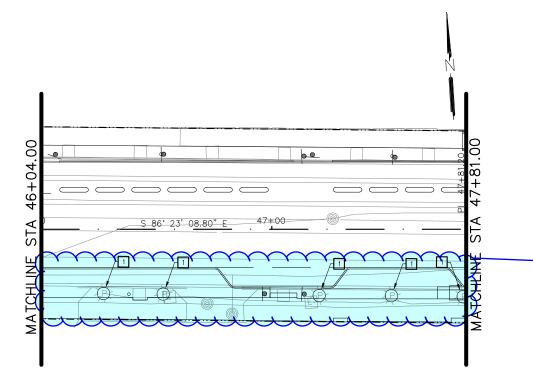

No ped poles salvaged east of Santa Rosa. Several of these are CPS hockey puck style luminaires and will need to be removed by CPS. Review and revise.

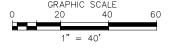

# # DEMO KEYED NOTES: (THIS SHEET ONLY)

REMOVE CITY OWNED LUMINAIRE AND ASSOCIATED CONDUCTORS AND RETURN TO OWNER.

# **GENERAL NOTES:**

- 1. CONTRACTOR TO COORDINATE WITH CPS ENERGY FOR REMOVAL AND RELOCATION OF CPSE EQUIPMENT.
- 2. PROTECT EXISTING TO REMAIN ELECTRICAL EQUIPMENT AND UNDERGROUND CIRCUITS. REPAIR AND RELOCATE AS NECESSARY TO MAINTAIN OPERATION. ADJUST ASSOCIATED IN-GRADE ELECTRICAL JUNCTION BOX COVER PLATES TO NEW ELEVATION. PROVIDE BOX EXTENSION AS NECESSARY.
- 3. REFER TO TRAFFIC SIGNAL DRAWINGS FOR TRAFFIC SIGNAL SCOPE OF WORK.

#### INTERIM REVIEW

DOCUMENT INCOMPLETE. NOT INTENDED FOR PERMIT, BIDDING OR CONSTRUCTION.
FNGINFFR: TRAVIS E. WILTSHIRE

PERMIT, BIDDING

INCLUDE: TRAVIS E. WILLS.

P.E. SERIAL NO: 85219

COMPANY NAME: CNG ENGINEERING, PLLC

COMPANY REG. NO. F-7964

DATE: 01-20-2023

EV. NO. DATE DESCRIPTION



CNG ENGINEERING MEP DESIGN PLANNING COMMISSIONING 1917 N NEW BRAUNFELS AVE, SUITE 201 SAN ANTONIO, TEXAS 78208 T 210.224.8841 F 210.224.8224 TBPE FIRM # F-7964



SAN ANTONIO I AUSTIN I HOUSTON I FORT WORTH I DALLAS 2000 NW LOOP 410 I SAN ANTONIO, TX 78213 I 210.375.9000 TEXAS ENGINEERING FIRM #470 | TEXAS SURVEYING FIRM #10028800



CITY OF SAN ANTONIO **PUBLIC WORKS DEPARTMENT** 


DOLOROSA

# **DEMOLITION** ELECTRICAL PLANS

STA 46+04.00 TO STA 47+81.00


SHEET 6 OF 8

				SHEET	01 0
DESIGN	CHECKED	DRAWN	PROJECT NO.	SUBMITTAL	SHEET NO.
JC	JC	CDC	23-03763	70%	386

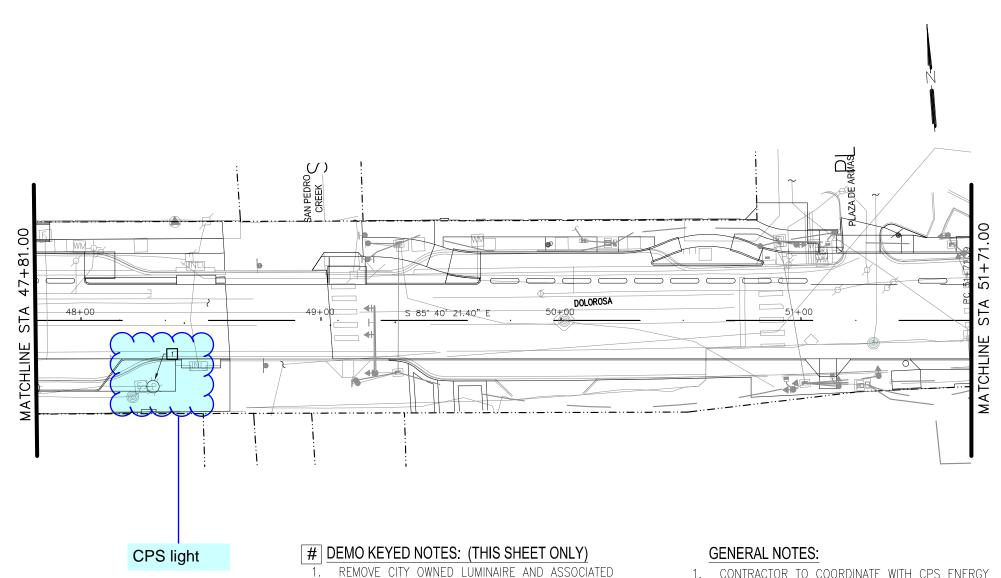

CONDUCTORS AND RETURN TO OWNER.

- 1. CONTRACTOR TO COORDINATE WITH CPS ENERGY FOR REMOVAL AND RELOCATION OF CPSE EQUIPMENT.
- 2. PROTECT EXISTING TO REMAIN ELECTRICAL EQUIPMENT AND UNDERGROUND CIRCUITS. REPAIR AND RELOCATE AS NECESSARY TO MAINTAIN OPERATION. ADJUST ASSOCIATED IN-GRADE ELECTRICAL JUNCTION BOX COVER PLATES TO NEW ELEVATION. PROVIDE BOX EXTENSION AS NECESSARY.
- 3. REFER TO TRAFFIC SIGNAL DRAWINGS FOR TRAFFIC SIGNAL SCOPE OF WORK.

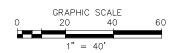

#### INTERIM REVIEW

DOCUMENT INCOMPLETE. NOT INTENDED FOR PERMIT, BIDDING OR CONSTRUCTION.
ENGINEER: TRAVIS E. WILTSHIRE

PERMIT, BIDDING
ENGINEER: TRAVIS E. M.C.

P.E. SERIAL NO: 85219

COMPANY NAME: CNG ENGINEERING, PLLC

COMPANY REG. NO. F-7964

DATE: 01-20-2023

EV. NO. DATE DESCRIPTION



CNG ENGINEERING MEP DESIGN PLANNING COMMISSIONING 1917 N NEW BRAUNFELS AVE, SUITE 201 SAN ANTONIO, TEXAS 78208 T 210.224.8841 F 210.224.8224 TBPE FIRM # F-7964



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CITY OF SAN ANTONIO **PUBLIC WORKS DEPARTMENT** 


DOLOROSA

#### **DEMOLITION** ELECTRICAL PLANS

STA 47+81.00 TO STA 51+71.00

SHEET 7 OF 8

				SHEET /	01 0
DESIGN	CHECKED	DRAWN	PROJECT NO.	SUBMITTAL	SHEET NO.
JC	JC	CDC	23-03763	70%	387

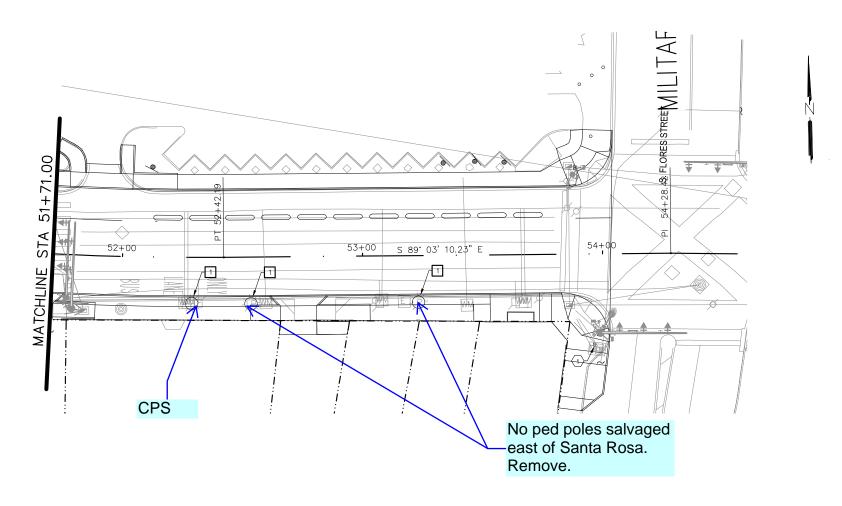

#### #> KEYED NOTES: (THIS SHEET ONLY)


1. EXISTING TRAFFIC SIGNAL CABINET. COORDINATE SCOPE OF WORK WITH TRAFFIC SIGNAL DRAWINGS.

#### # DEMO KEYED NOTES: (THIS SHEET ONLY)

REMOVE CITY OWNED LUMINAIRE AND ASSOCIATED CONDUCTORS AND RETURN TO OWNER.

#### **GENERAL NOTES:**

- 1. CONTRACTOR TO COORDINATE WITH CPS ENERGY FOR REMOVAL AND RELOCATION OF CPSE EQUIPMENT.
- 2. PROTECT EXISTING TO REMAIN ELECTRICAL EQUIPMENT AND UNDERGROUND CIRCUITS. REPAIR AND RELOCATE AS NECESSARY TO MAINTAIN OPERATION. ADJUST ASSOCIATED IN-GRADE ELECTRICAL JUNCTION BOX COVER PLATES TO NEW ELEVATION. PROVIDE BOX EXTENSION AS NECESSARY.
- 3. REFER TO TRAFFIC SIGNAL DRAWINGS FOR TRAFFIC SIGNAL SCOPE OF WORK.

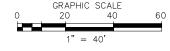

#### INTERIM REVIEW

DOCUMENT INCOMPLETE. NOT INTENDED FOR PERMIT, BIDDING OR CONSTRUCTION.
FNGINFFR: TRAVIS E. WILTSHIRE

PERMIT, BIDDING - TRAVIS E. WILL.

P.E. SERIAL NO: 85219

COMPANY NAME: CNG ENGINEERING, PLLC

COMPANY REG. NO. F-7964

DATF: 01-20-2023

EV. NO. DATE DESCRIPTION



CNG ENGINEERING MEP DESIGN PLANNING COMMISSIONING 1917 N NEW BRAUNFELS AVE, SUITE 201 SAN ANTONIO, TEXAS 78208 T 210.224.8841 F 210.224.8224 TBPE FIRM # F-7964



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CITY OF SAN ANTONIO **PUBLIC WORKS DEPARTMENT** 


DOLOROSA


#### **DEMOLITION** ELECTRICAL PLANS

STA 51+71.00 TO STA 54+29.00

SHEET R OF R

				SHEET 0	01 0
DESIGN	CHECKED	DRAWN	PROJECT NO.	SUBMITTAL	SHEET NO.
JC	JC	CDC	23-03763	70%	388

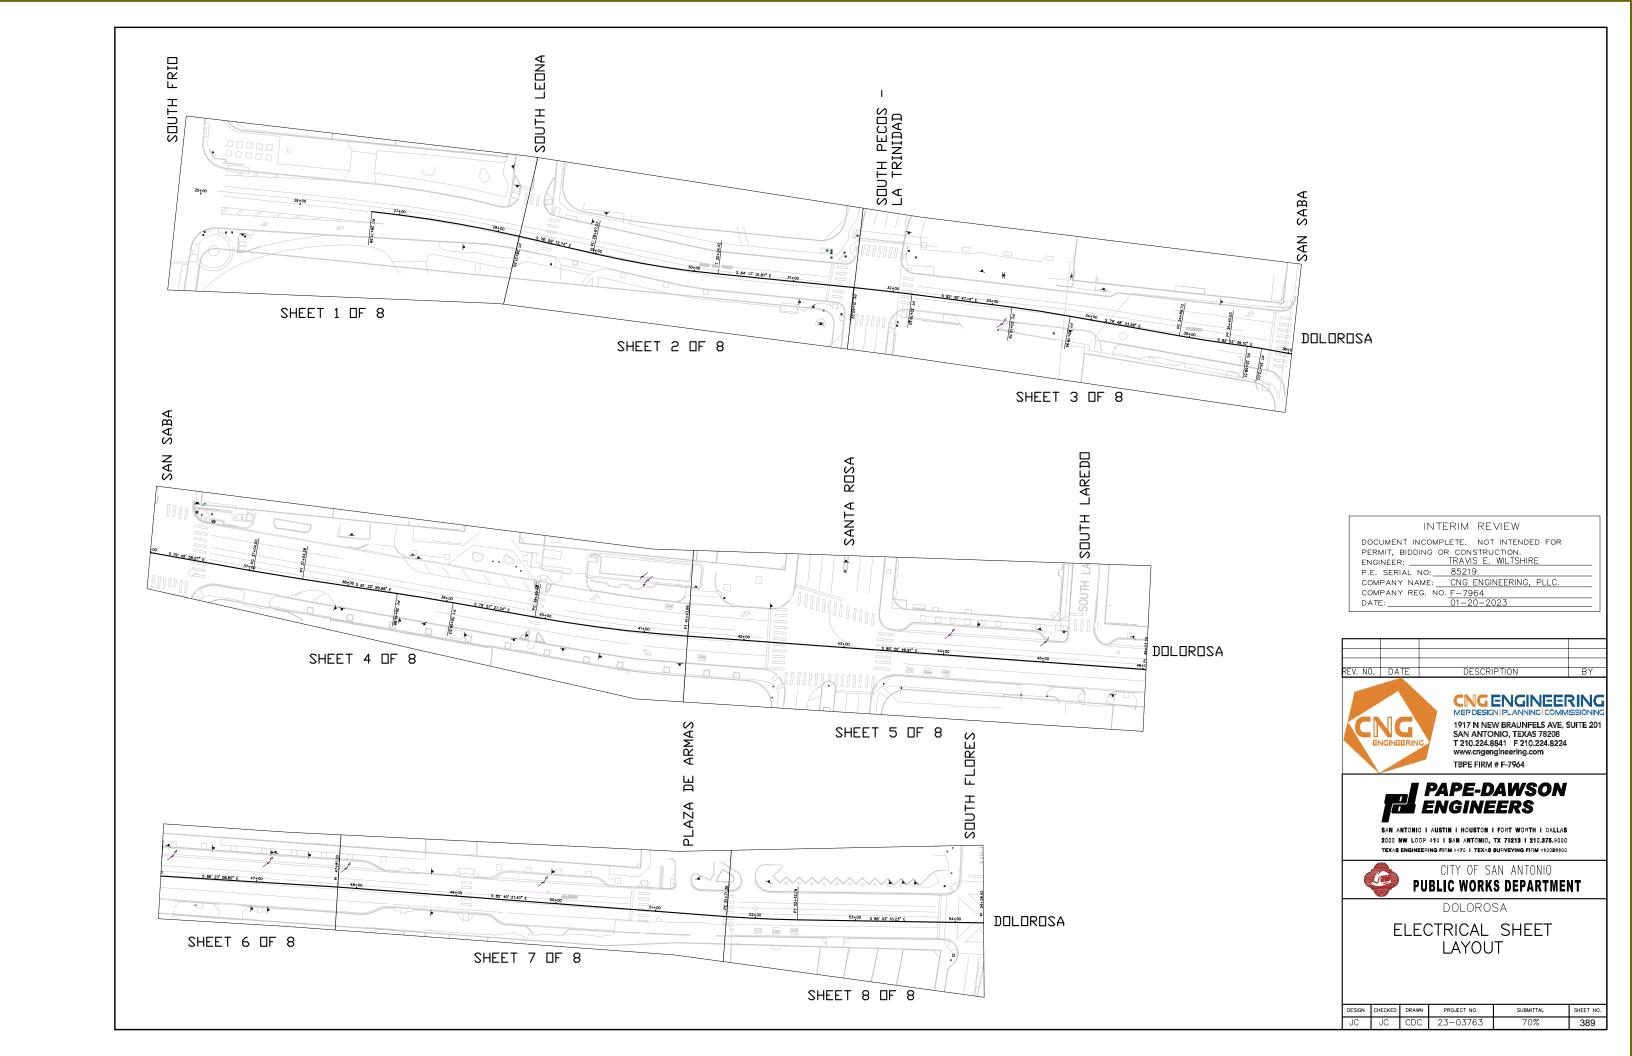

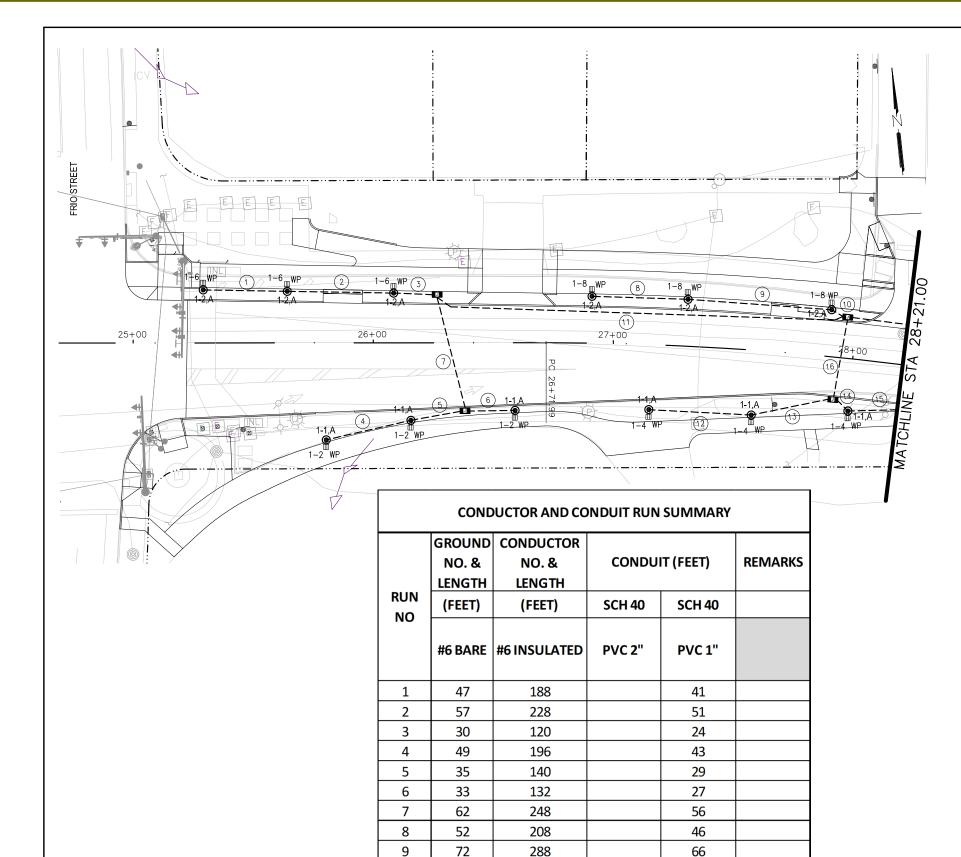

10

11

12

13

14

15

16

**TOTALS** 

20

184

55

47

20

42

47

313

80

1104

220

188

80

168

188

1252

14

49

41

14

36

271

178

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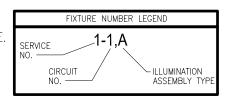
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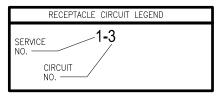
(#) KEYED NOTES: (THIS SHEET ONLY)


NEW LUMINAIRE POLE MOUNTED AT FINISHED GRADE. (TYPICAL).

#### **GENERAL NOTES:**

- REFER TO LIGHTING FIXTURE SCHEDULE FOR LUMINAIRE POLE TYPE.
- COORDINATE U.G. CONDUIT INSTALLATION AROUND DRAINAGE STRUCTURE AND OTHER UTILITIES.
- PROVIDE #6 CU. WIRING IN 2" PVC CONDUIT UNDERGROUND CIRCUITS FOR ILLUMINATED BOLLARDS, PEDESTRIAN LIGHTING AND POLE MOUNTED RECEPTACLES.
- SPLICE #10 TO #6 HOME RUN CONDUCTORS AT BASE OF EACH POLE AND RUN CONDUCTORS FROM BASE OF POLE TO POLE MOUNTED RECEPTACLE.





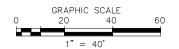

#### ILLUMINATION LEGEND

PEDESTRIAN LIGHTING POLE GFCI RECEPTACLE WITH WHILE-IN-USE COVER EXISTING RACEWAY TO REMAIN CONDUIT UNDERGROUND OR CAST IN STRUCTURE WITH CONDUCTORS. SEE SUMMARY. GROUND BOX WITH CONC. APRON ♠ ES#1 ELECTRIC SERVICE/POLE #NUMBER (XX)CONDUIT RUN NUMBER (PP) POWER POLE

INTERIM REVIEW
DOCUMENT INCOMPLETE. NOT INTENDED FOR PERMIT, BIDDING OR CONSTRUCTION. ENGINEER: TRAVIS E. WILTSHIRE
P.E. SERIAL NO: <u>85219</u>
COMPANY NAME: CNG ENGINEERING, PLLC.
COMPANY REG. NO. F-7964
DATE: 01-20-2023





TBPE FIRM # F-7964

SAN ANTONIO I AUSTIN I HOUSTON I FORT WORTH I DALLAS 2000 NW LOOP 410 I SAN ANTONIO, TX 78213 I 210.375.9000 TEXAS ENGINEERING FIRM #470 | TEXAS SURVEYING FIRM #1002680



CITY OF SAN ANTONIO PUBLIC WORKS DEPARTMENT


DOLOROSA

ELECTRICAL PLANS

STA BEGIN TO STA 28+21.00

				SHEET 1	OF 8
ESIGN	CHECKED	DRAWN	PROJECT NO.	SUBMITTAL	SHEET NO.
JC	JC	CDC	23-03763	70%	390

COSA PM team will need to see a roll plot drawing or digital file with all utilities, trees, and light pole foundations. I need to see this before proceeding to 95% design. I cannot make comments on planting or illumination layouts without seeing how underground conflicts will impact what is proposed.

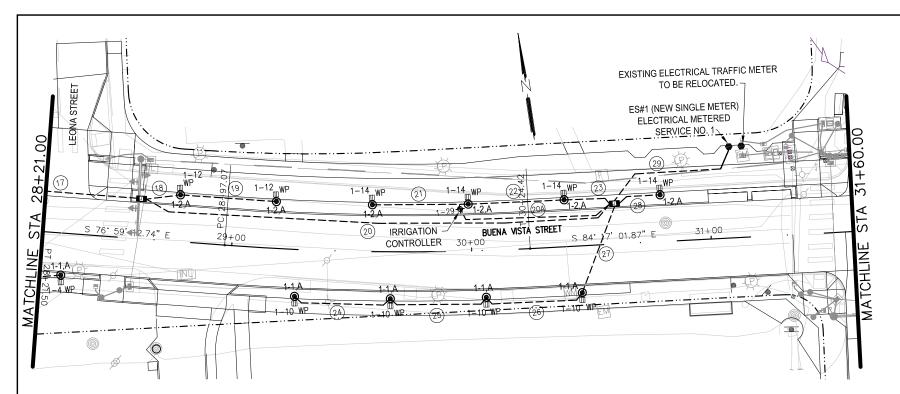

#### **CONDUCTOR AND CONDUIT RUN SUMMARY** GROUND CONDUCTOR **CONDUIT (FEET) REMARKS** NO. & NO. & LENGTH **LENGTH** RUN (FEET) (FEET) **SCH 40 SCH 40** NO #6 BARE | #6 INSULATED **PVC 2**" PVC 1" 20A TOTALS


#### #> KEYED NOTES: (THIS SHEET ONLY)


NEW LUMINAIRE POLE MOUNTED AT FINISHED GRADE. (TYPICAL).

#### GENERAL NOTES:

- 1. REFER TO LIGHTING FIXTURE SCHEDULE FOR LUMINAIRE POLE TYPE.
- 2. COORDINATE U.G. CONDUIT INSTALLATION AROUND DRAINAGE STRUCTURE AND OTHER UTILITIES.
- 3. PROVIDE #6 CU. WIRING IN 2" PVC CONDUIT UNDERGROUND CIRCUITS FOR ILLUMINATED BOLLARDS, PEDESTRIAN LIGHTING AND POLE MOUNTED RECEPTACLES.
- 4. SPLICE #10 TO #6 HOME RUN CONDUCTORS AT BASE OF EACH POLE AND RUN CONDUCTORS FROM BASE OF POLE TO POLE MOUNTED RECEPTACLE.

# SERVICE NO. CIRCUIT NO. ASSEMBLY TYPE

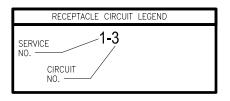

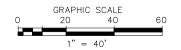

#### **ILLUMINATION LEGEND**

PEDESTRIAN LIGHTING POLE

GFCI RECEPTACLE WITH WHILE—IN—USE COVER

EXISTING RACEWAY TO REMAIN


CONDUIT UNDERGROUND OR CAST IN STRUCTURE
WITH CONDUCTORS. SEE SUMMARY.

GROUND BOX WITH CONC. APRON

ELECTRIC SERVICE/POLE #NUMBER

CONDUIT RUN NUMBER

POWER POLE

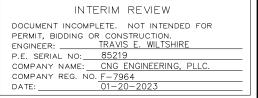





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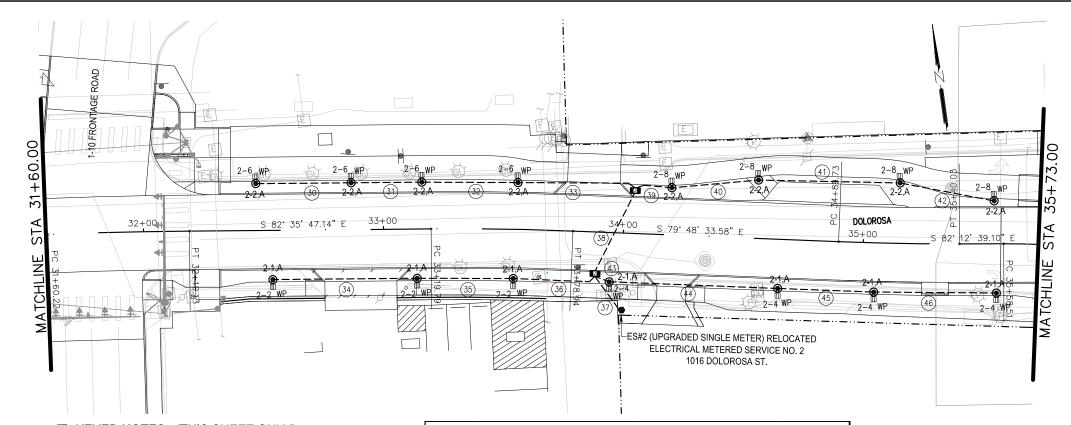
CITY OF SAN ANTONIO
PUBLIC WORKS DEPARTMENT

DOLOROSA

ELECTRICAL PLANS

STA 28+21.00 STA 31+60.00

				SHEET 2	OF <b>8</b>
GN	CHECKED	DRAWN	PROJECT NO.	SUBMITTAL	SHEET NO.
	JC	CDC	23-03763	70%	201



(#) KEYED NOTES: (THIS SHEET ONLY)


NEW LUMINAIRE POLE MOUNTED AT FINISHED GRADE. (TYPICAL).


#### **GENERAL NOTES:**


- REFER TO LIGHTING FIXTURE SCHEDULE FOR LUMINAIRE POLE TYPE.
- COORDINATE U.G. CONDUIT INSTALLATION AROUND DRAINAGE STRUCTURE AND OTHER UTILITIES.
- PROVIDE #6 CU. WIRING IN 2" PVC CONDUIT UNDERGROUND CIRCUITS FOR ILLUMINATED BOLLARDS, PEDESTRIAN LIGHTING AND POLE MOUNTED RECEPTACLES.
- SPLICE #10 TO #6 HOME RUN CONDUCTORS AT BASE OF EACH POLE AND RUN CONDUCTORS FROM BASE OF POLE TO POLE MOUNTED RECEPTACLE.


	CONDUCTOR AND CONDUIT RUN SUMMARY								
	GROUND NO. & LENGTH	CONDUCTOR NO. & LENGTH	CONDU	REMARKS					
RUN NO	(FEET)	(FEET)	SCH 40	SCH 40					
NO	#6 BARE	#6 INSULATED	PVC 2"	PVC 1"					
30	52	208		46					
31	42	168		36					
32	54	216		48					
33	62	248		56					
34	73	292		67					
35	53	212		47					
36	48	192		42					
37	34	408	28						
38	53	318	47						
39	28	112		22					
40	62	248		56					
41	58	232		52					
42	53	212		47					
43	20	80		14					
44	83	332		77					
45	53	212		47					
46	65	260		59					
TOTALS	893	3950	75	716					

#### **ILLUMINATION LEGEND**

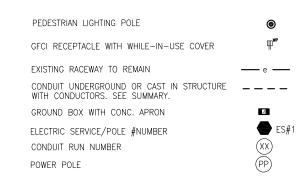

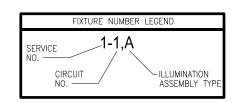

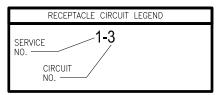

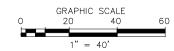

INTERIM REVIEW DOCUMENT INCOMPLETE. NOT INTENDED FOR PERMIT, BIDDING OR CONSTRUCTION.
FNGINFFR: TRAVIS E. WILTSHIRE ENGINEER: TRAVIS
P.E. SERIAL NO: 85219 COMPANY NAME: CNG ENGINEERING, PLLC
COMPANY REG. NO. F-7964
DATE: 01-20-2023





SAN ANTONIO I AUSTIN I HOUSTON I FORT WORTH I DALLAS 2000 NW LOOP 410 I SAN ANTONIO, TX 78213 I 210.375,9000 TEXAS ENGINEERING FIRM #470 | TEXAS SURVEYING FIRM #10028800




CITY OF SAN ANTONIO **PUBLIC WORKS DEPARTMENT** 

DOLOROSA

ELECTRICAL PLANS

STA 31+60.00 TO STA 35+73.00

				SHEET 3	OF <b>8</b>
ESIGN	CHECKED	DRAWN	PROJECT NO.	SUBMITTAL	SHEET NO.
JC	JC	CDC	23-03763	70%	392

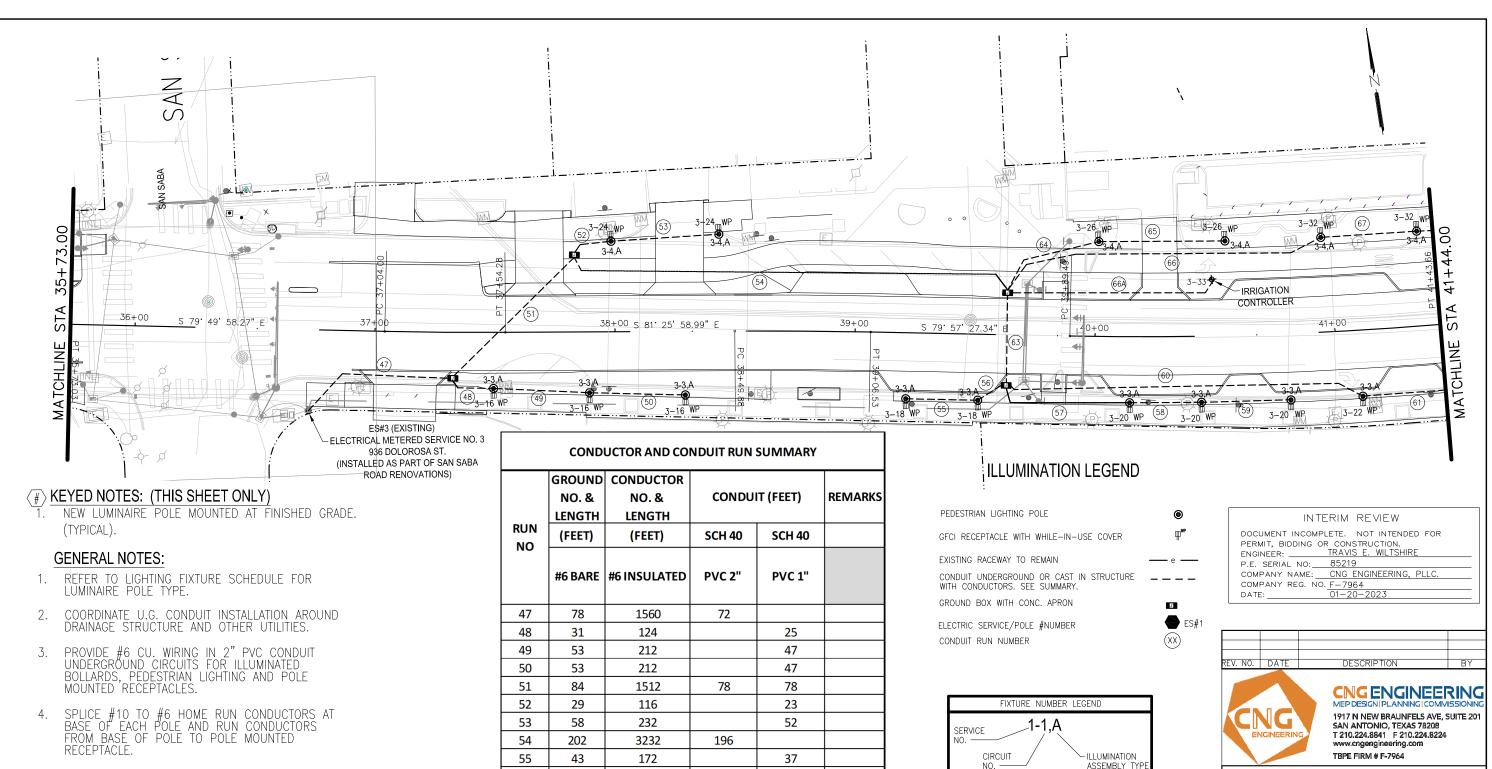

66A

TOTALS

#### PAPE-DAWSON **ENGINEERS** SAN ANTONIO I AUSTIN I HOUSTON I FORT WORTH I DALLAS

2000 NW LOOP 410 | SAN ANTONIO, TX 78213 | 210.375.9000 TEXAS ENGINEERING FIRM #470 | TEXAS SURVEYING FIRM #10028800



RECEPTACLE CIRCUIT LEGEND

GRAPHIC SCALE

SERVICE

CIRCUIT


CITY OF SAN ANTONIO PUBLIC WORKS DEPARTMENT

DOLOROSA

ELECTRICAL PLANS

STA 35+73.00 TO STA 41+44.00

				SHEET 4	OF <b>8</b>
DESIGN	CHECKED	DRAWN	PROJECT NO.	SUBMITTAL	SHEET NO.
JC	JC	CDC	23-03763	70%	393

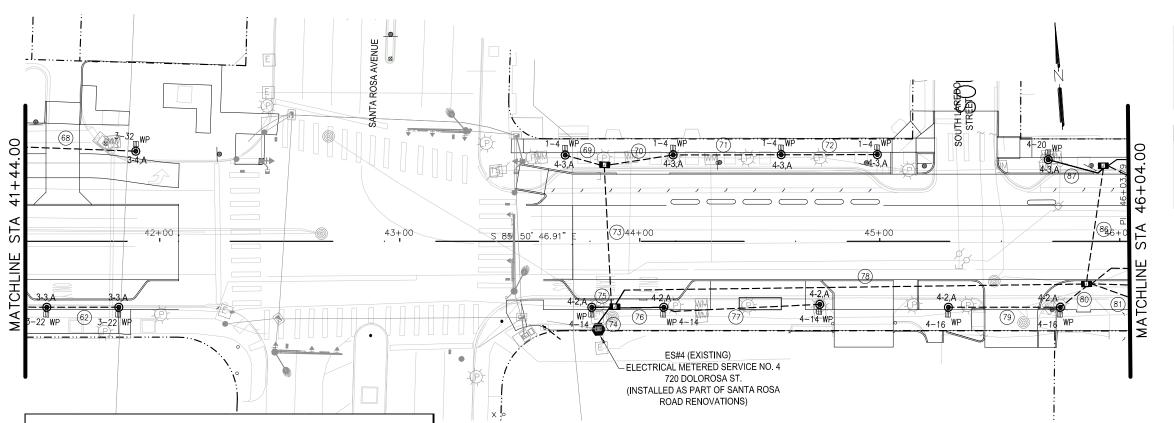

#### **CONDUCTOR AND CONDUIT RUN SUMMARY**

	GROUND NO. & LENGTH	CONDUCTOR NO. & LENGTH	CONDUI	T (FEET)	REMARKS
RUN	(FEET)	(FEET)	SCH 40	SCH 40	
NO	#6 BARE	#6 INSULATED	PVC 2"	PVC 1"	
62	43	172		37	
68	65	260		59	
69	30	120		24	
70	42	168		36	
71	58	232		52	
72	52	208		46	
73	74	296	68		
74	27	486	21		
75	22	88		16	
76	34	136		28	
77	77	308		71	
78	224	3136	218		
79	59	236		53	
80	26	104		20	
81	43	172		37	
86	63	378	57		
87	36	144		30	
TOTALS	975	6644	364	509	


#### (#) KEYED NOTES: (THIS SHEET ONLY)


NEW LUMINAIRE POLE MOUNTED AT FINISHED GRADE. (TYPICAL).


#### **GENERAL NOTES:**


- REFER TO LIGHTING FIXTURE SCHEDULE FOR LUMINAIRE POLE TYPE.
- COORDINATE U.G. CONDUIT INSTALLATION AROUND DRAINAGE STRUCTURE AND OTHER UTILITIES.
- PROVIDE #6 CU. WIRING IN 2" PVC CONDUIT UNDERGROUND CIRCUITS FOR ILLUMINATED BOLLARDS, PEDESTRIAN LIGHTING AND POLE MOUNTED RECEPTACLES.
- SPLICE #10 TO #6 HOME RUN CONDUCTORS AT BASE OF EACH POLE AND RUN CONDUCTORS FROM BASE OF POLE TO POLE MOUNTED RECEPTACLE.

#### ILLUMINATION LEGEND

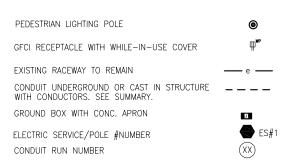

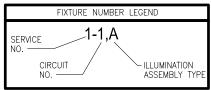

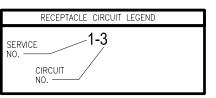

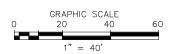

#### INTERIM REVIEW

DOCUMENT INCOMPLETE. NOT INTENDED FOR PERMIT, BIDDING OR CONSTRUCTION.
FNGINFFR: TRAVIS E. WILTSHIRE P.E. SERIAL NO: 85219

COMPANY NAME: CNG ENGINEERING, PLLC COMPANY REG. NO. F-7964
DATE: 01-20-202.

DESCRIPTION EV. NO. DATE



CNG ENGINEERING MEP DESIGN PLANNING COMMISSIONING 1917 N NEW BRAUNFELS AVE, SUITE 201 SAN ANTONIO, TEXAS 78208 T 210.224.8841 F 210.224.8224 TBPE FIRM # F-7964



SAN ANTONIO I AUSTIN I HOUSTON I FORT WORTH I DALLAS 2000 NW LOOP 410 | SAN ANTONIO, TX 78213 | 210.375.9000 TEXAS ENGINEERING FIRM #470 | TEXAS SURVEYING FIRM #10029800




CITY OF SAN ANTONIO **PUBLIC WORKS DEPARTMENT** 

DOLOROSA

ELECTRICAL PLANS

STA 41+44.00 TO STA 46+04.00

				SHEET 5	OF <b>8</b>
ESIGN	CHECKED	DRAWN	PROJECT NO.	SUBMITTAL	SHEET NO.
JC	JC	CDC	23-03763	70%	394

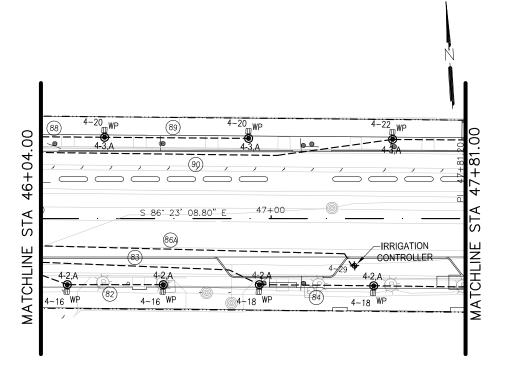

	CONDUCTOR AND CONDUIT RUN SUMMARY								
	GROUND NO. & LENGTH	CONDUCTOR NO. & LENGTH	COND	REMARKS					
RUN NO	(FEET)	(FEET)	SCH 40	SCH 40					
NO	#6 BARE	#6 INSULATED	PVC 2"	PVC 1"					
82	47	188		47					
83	118	472		118					
84	54	216		54					
86A	161	322		161					
88	43	172		43					
89	67	268		67					
90	166	664		166					
TOTALS	656	2302	0	656					


#### # KEYED NOTES: (THIS SHEET ONLY)

NEW LUMINAIRE POLE MOUNTED AT FINISHED GRADE. (TYPICAL).

#### **GENERAL NOTES:**

- 1. REFER TO LIGHTING FIXTURE SCHEDULE FOR LUMINAIRE POLE TYPE.
- 2. COORDINATE U.G. CONDUIT INSTALLATION AROUND DRAINAGE STRUCTURE AND OTHER UTILITIES.
- 3. PROVIDE #6 CU. WIRING IN 2" PVC CONDUIT UNDERGROUND CIRCUITS FOR ILLUMINATED BOLLARDS, PEDESTRIAN LIGHTING AND POLE MOUNTED RECEPTACLES.
- 4. SPLICE #10 TO #6 HOME RUN CONDUCTORS AT BASE OF EACH POLE AND RUN CONDUCTORS FROM BASE OF POLE TO POLE MOUNTED RECEPTACLE.


# SERVICE NO. CIRCUIT ILLUMINATION

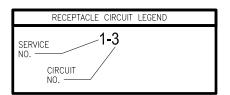




ASSEMBLY TYP

#### ILLUMINATION LEGEND

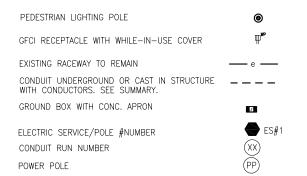

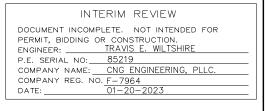





SAN ANTONIO I AUSTIN I HOUSTON I FORT WORTH I DALLAS 2000 NW LOOP 410 I SAN ANTONIO, TX 78213 I 210.375,9000 Texas engineering firm #470 I Texas Surveying firm #10028800



CITY OF SAN ANTONIO
PUBLIC WORKS DEPARTMENT


DOLOROSA

ELECTRICAL PLANS

STA 46+04.00 TO STA 47+81.00

 DESIGN
 CHECKED
 DRAWN
 PROJECT NO.
 SUBMITTAL
 SHEET NO.

 JC
 JC
 CDC
 23-03763
 70%
 395

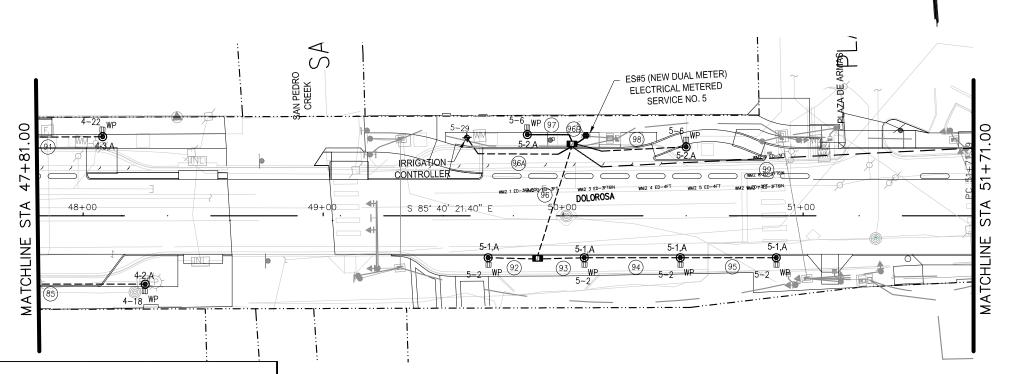

#### **CONDUCTOR AND CONDUIT RUN SUMMARY**

	GROUND NO. & LENGTH	CONDUCTOR NO. & LENGTH	CONDU	CONDUIT (FEET)					
RUN	(FEET)	(FEET)	SCH 40	SCH 40					
NO	#6 BARE	#6 INSULATED	PVC 2"	PVC 1"					
85	96	384		90					
91	72	288		66					
92	34	136		28					
93	32	128		26					
94	53	212		47					
95	53	212		47					
96	64	256	58						
96A	57	114		51					
96B	22	264	16						
97	34	68		28					
98	60	120	·	54					
99	262	2096	256						
TOTALS	839	4278	330	437					


#### $\langle \# \rangle$ KEYED NOTES: (THIS SHEET ONLY)


1. NEW LUMINAIRE POLE MOUNTED AT FINISHED GRADE. (TYPICAL).


#### **GENERAL NOTES:**


- 1. REFER TO LIGHTING FIXTURE SCHEDULE FOR LUMINAIRE POLE TYPE.
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#### ILLUMINATION LEGEND



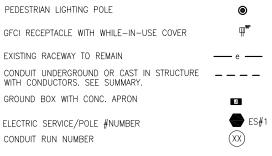

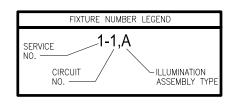

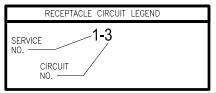


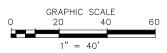INTERIM REVIEW

DOCUMENT INCOMPLETE. NOT INTENDED FOR PERMIT, BIDDING OR CONSTRUCTION.
ENGINEER: TRAVIS E. WILTSHIRE

P.E. SERIAL NO: 85219

COMPANY NAME: CNG ENGINEERING, PLLC.
COMPANY REG. NO. F-7964
DATE: 01-20-2023

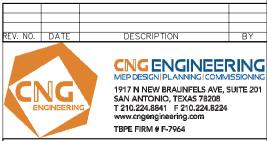



SAN ANTONIO I AUSTIN I HOUSTON I FORT WORTH I DALLAS 2000 NW LOOP 410 I SAN ANTONIO, TX 78213 I 210.375,9000 Texas engineering firm #470 I Texas Surveying firm #10029800



CITY OF SAN ANTONIO
PUBLIC WORKS DEPARTMENT


DOLOROSA

ELECTRICAL PLANS

STA 47+81.00 TO STA 51+71.00

SHEET **7** OF **8**CKED DRAWN PROJECT NO. SUBMITTAL SHEET NO.

C CDC 23-03763 70% 396

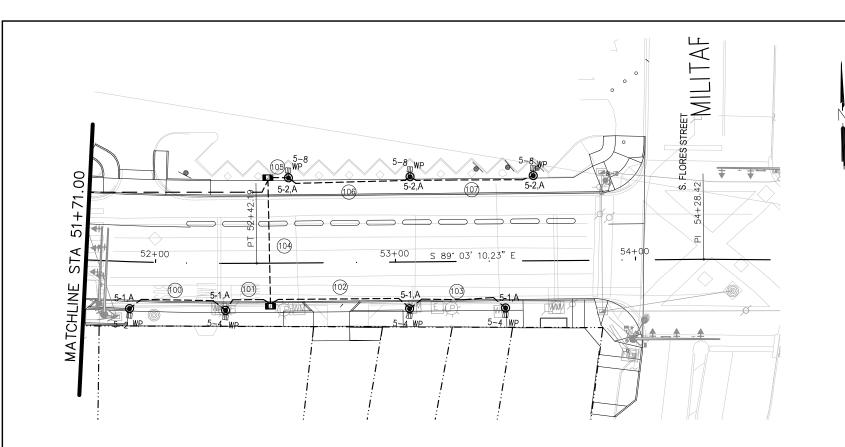

	CONDUC	CTOR AND CONI	OUIT RUN S	SUMMARY	,
	GROUND NO. & LENGTH	CONDUCTOR NO. & LENGTH	CONDU	IT (FEET)	REMARKS
RUN NO	(FEET)	(FEET)	SCH 40	SCH 40	
NO	#6 BARE	#6 INSULATED	PVC 2"	PVC 1"	
100	54	216		48	
101	32	128		26	
102	72	288		66	
103	53	212		47	
104	65	260	59		
105	22	88		16	
106	6	24		58	
107	64	256		58	
TOTALS	368	1472	59	319	

#### #> KEYED NOTES: (THIS SHEET ONLY)


1. NEW LUMINAIRE POLE MOUNTED AT FINISHED GRADE. (TYPICAL).


#### **GENERAL NOTES:**

- 1. REFER TO LIGHTING FIXTURE SCHEDULE FOR LUMINAIRE POLE TYPE.
- 2. COORDINATE U.G. CONDUIT INSTALLATION AROUND DRAINAGE STRUCTURE AND OTHER UTILITIES.
- PROVIDE #6 CU. WIRING IN 2" PVC CONDUIT UNDERGROUND CIRCUITS FOR ILLUMINATED BOLLARDS, PEDESTRIAN LIGHTING AND POLE MOUNTED RECEPTACLES.
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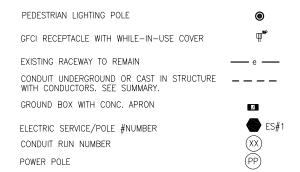
#### FIXTURE NUMBER LEGEND \_1-1,A SERVICE





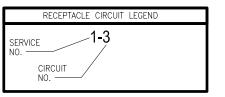
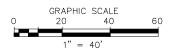
#### ILLUMINATION LEGEND





DOCUMENT INCOMPLETE. NOT INTENDED FOR PERMIT, BIDDING OR CONSTRUCTION.
ENGINEER: TRAVIS E. WILTSHIRE P.E. SERIAL NO: 85219 COMPANY NAME: CNG ENGINEERING, PLLC
COMPANY REG. NO. F-7964
DATE: 01-20-2023

DESCRIPTION EV. NO. DATE



CNG ENGINEERING MEP DESIGN PLANNING COMMISSIONING 1917 N NEW BRAUNFELS AVE, SUITE 201 SAN ANTONIO, TEXAS 78208 T 210.224.8841 F 210.224.8224 TBPE FIRM # F-7964



SAN ANTONIO I AUSTIN I HOUSTON I FORT WORTH I DALLAS 2000 NW LOOP 410 | SAN ANTONIO, TX 78213 | 210.375.9000 TEXAS ENGINEERING FIRM #470 | TEXAS SURVEYING FIRM #10028800



CITY OF SAN ANTONIO **PUBLIC WORKS DEPARTMENT** 


DOLOROSA

ELECTRICAL PLANS

STA 51+71.00 TO STA 54+29.00

SHEET 8 OF 8 SUBMITTAL SHEET NO.

DESIGN CHECKED DRAWN PROJECT NO. JC JC CDC 23-03763 70% 397

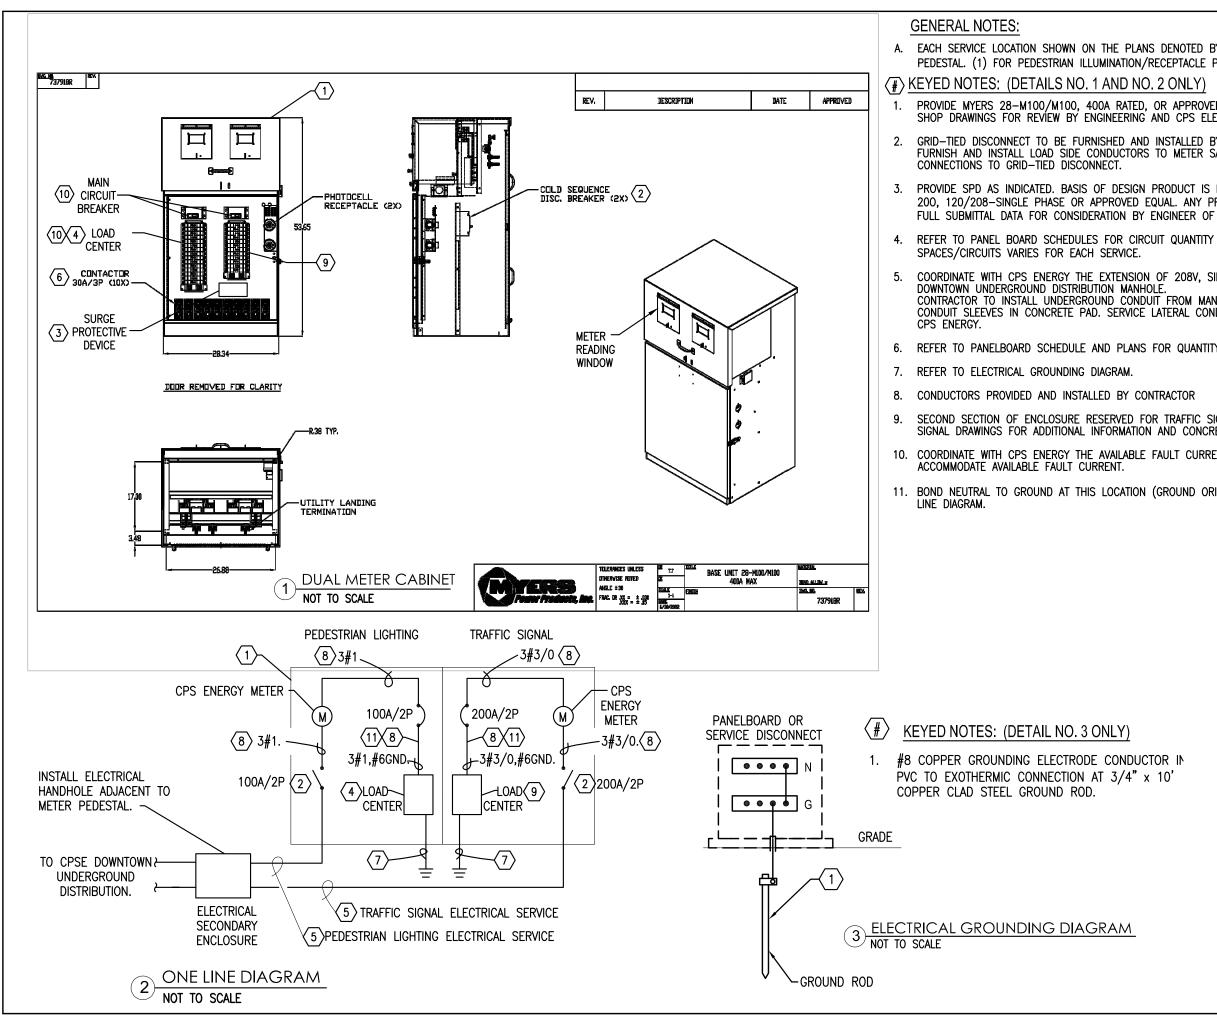

A. EACH SERVICE LOCATION SHOWN ON THE PLANS DENOTED BY 'ES#' WILL HAVE A DOUBLE SECTION SERVICE PEDESTAL. (1) FOR PEDESTRIAN ILLUMINATION/RECEPTACLE POWER AND (1) FOR TRAFFIC CONTROLS.

- PROVIDE MYERS 28-M100/M100, 400A RATED, OR APPROVED EQUAL. CONTRACTOR TO SUBMIT DIMENSIONED SHOP DRAWINGS FOR REVIEW BY ENGINEERING AND CPS ELECTRIC,
- GRID-TIED DISCONNECT TO BE FURNISHED AND INSTALLED BY DUAL METER MANUFACTURER. CONTRACTOR TO FURNISH AND INSTALL LOAD SIDE CONDUCTORS TO METER SAFETY SOCKET. CPS ENERGY TO MAKE ALL
- PROVIDE SPD AS INDICATED. BASIS OF DESIGN PRODUCT IS LEA INTERNATIONAL, TRANSECTOR SPD SP PLUS 200, 120/208-SINGLE PHASE OR APPROVED EQUAL. ANY PROPOSED SUBSTITUTION MUST BE REQUESTED WITH FULL SUBMITTAL DATA FOR CONSIDERATION BY ENGINEER OF RECORD. CONNECT TO PANEL USING #2 WIRING.
- REFER TO PANEL BOARD SCHEDULES FOR CIRCUIT QUANTITY AND PANEL CONFIGURATION. NUMBER OF
- COORDINATE WITH CPS ENERGY THE EXTENSION OF 208V, SINGLE PHASE SERVICE LINE FROM THE NEAREST CONTRACTOR TO INSTALL UNDERGROUND CONDUIT FROM MANHOLE TO ELECTRICAL SERVICE PEDESTAL AND CONDUIT SLEEVES IN CONCRETE PAD. SERVICE LATERAL CONDUCTORS ARE TO FURNISHED AND INSTALLED BY
- 6. REFER TO PANELBOARD SCHEDULE AND PLANS FOR QUANTITY OF CONTACTORS REQUIRED PER SERVICE.
- SECOND SECTION OF ENCLOSURE RESERVED FOR TRAFFIC SIGNAL SERVICE AND EQUIPMENT. REFER TO TRAFFIC SIGNAL DRAWINGS FOR ADDITIONAL INFORMATION AND CONCRETE SLEEVE REQUIREMENTS.
- 10. COORDINATE WITH CPS ENERGY THE AVAILABLE FAULT CURRENT RATING. ADJUST AIC RATINGS AS REQUIRED TO

11. BOND NEUTRAL TO GROUND AT THIS LOCATION (GROUND ORIGINATION). REFER TO TYPICAL DUAL METER ONE

INTERIM REVIEW DOCUMENT INCOMPLETE. NOT INTENDED FOR PERMIT, BIDDING OR CONSTRUCTION.
ENGINEER: TRAVIS E. WILTSHIR ENGINEER: \_ P.E. SERIAL NO: 85219 COMPANY NAME: CNG ENGINEERING, PLLC COMPANY REG. NO. F-7964
DATF: 01-20-202





SAN ANTONIO I AUSTIN I HOUSTON I FORT WORTH I DALLAS 2000 NW LOOP 410 | SAN ANTONIO, TX 78213 | 210.375.9000 TEXAS ENGINEERING FIRM #470 | TEXAS SURVEYING FIRM #1002680




CITY OF SAN ANTONIO PUBLIC WORKS DEPARTMENT

DOLOROSA

ELECTRICAL SERVICE ONE-LINE DIAGRAM DUAL METER

398

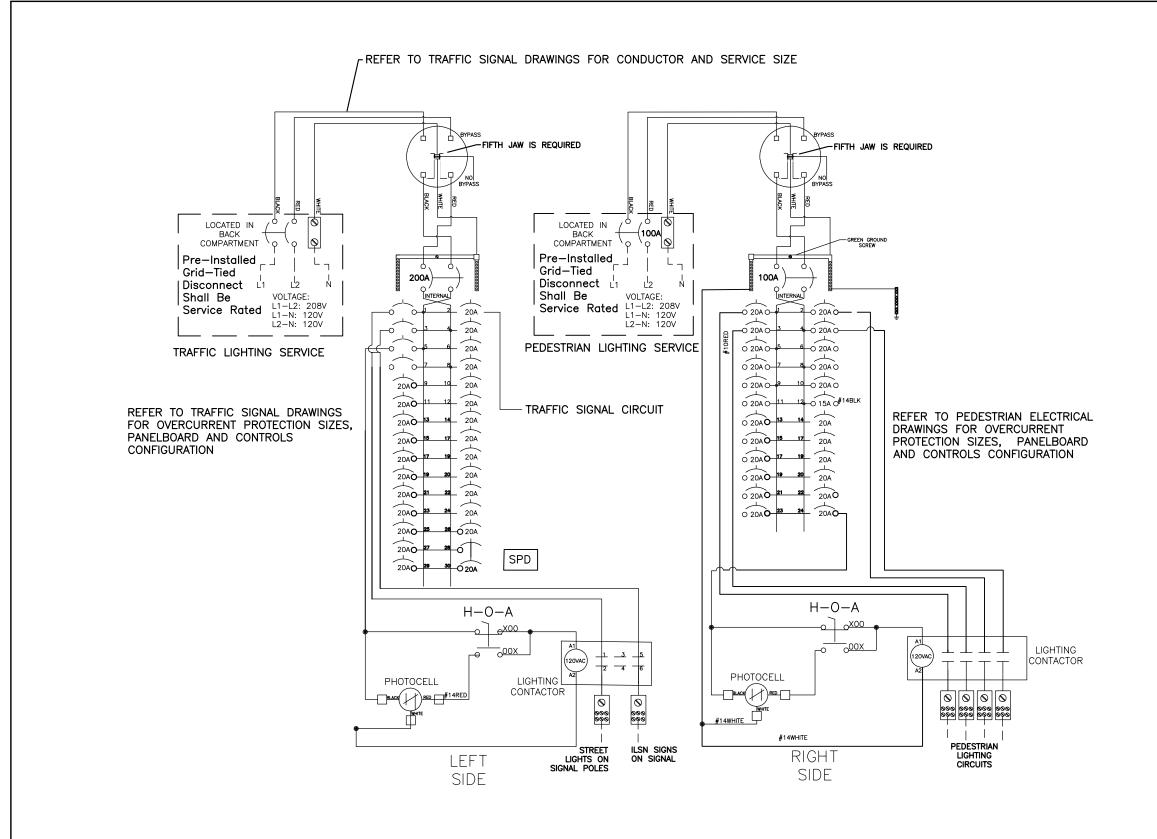

TYPICAL DUAL METER ONE LINE DIAGRAM

NOT TO SCALE

#### INTERIM REVIEW

DOCUMENT INCOMPLETE. NOT INTENDED FOR PERMIT, BIDDING OR CONSTRUCTION.
ENGINEER: TRAVIS E. WILTSHIR ENGINEER: \_\_\_\_\_

P.E. SERIAL NO: 85219
COMPANY NAME: CNG ENGINEERING, PLLC





CNG ENGINEERING MEP DESIGN PLANNING COMMISSIONING 1917 N NEW BRAUNFELS AVE, SUITE 201 SAN ANTONIO, TEXAS 78208 T 210.224.8841 F 210.224.8224 TBPE FIRM # F-7964

PAPE-DAWSON ENGINEERS

SAN ANTONIO I AUSTIN I HOUSTON I FORT WORTH I DALLAS 2000 NW LOOP 410 I SAN ANTONIO, TX 78213 I 210.375.9000 TEXAS ENGINEERING FIRM #470 | TEXAS SURVEYING FIRM #10028800




CITY OF SAN ANTONIO PUBLIC WORKS DEPARTMENT

DOLOROSA

ELECTRICAL DUAL METER ONE-LINE DIAGRAM

DESIGN	CHECKED	DRAWN	PROJECT NO.	SUBMITTAL	SHEET NO.
JC	JC	CDC	23-03763	70%	399

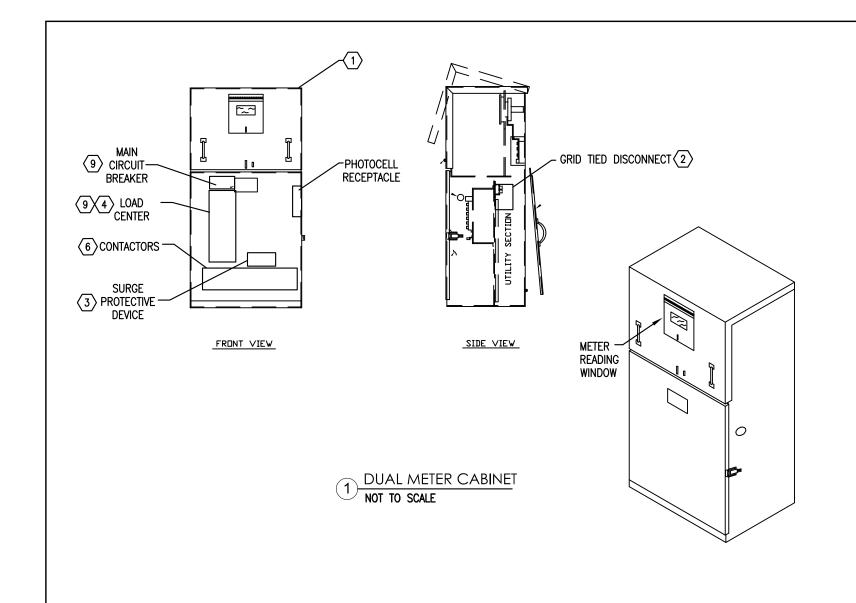


#### **GENERAL NOTES:**

A. EACH SERVICE LOCATION SHOWN ON THE PLANS DENOTED BY 'ES#' WILL HAVE A DOUBLE SECTION SERVICE PEDESTAL. (1) FOR PEDESTRIAN ILLUMINATION/RECEPTACLE POWER AND (1) FOR TRAFFIC CONTROLS.

#### (#) KEYED NOTES: (DETAILS NO. 1 AND NO. 2 ONLY)


- PROVIDE MYERS 28-SINGLE METER CABINET, 400A RATED, OR APPROVED EQUAL. CONTRACTOR TO SUBMIT DIMENSIONED SHOP DRAWINGS FOR REVIEW BY ENGINEERING AND CPS ELECTRIC,
- 2. GRID—TIED DISCONNECT TO BE FURNISHED AND INSTALLED BY DUAL METER MANUFACTURER. CONTRACTOR TO FURNISH AND INSTALL LOAD SIDE CONDUCTORS TO METER SAFETY SOCKET. CPS ENERGY TO MAKE ALL CONNECTIONS TO GRID—TIED DISCONNECT.
- 3. PROVIDE SPD AS INDICATED. BASIS OF DESIGN PRODUCT IS LEA INTERNATIONAL, TRANSECTOR SPD SP PLUS 200, 120/208—SINGLE PHASE OR APPROVED EQUAL. ANY PROPOSED SUBSTITUTION MUST BE REQUESTED WITH FULL SUBMITTAL DATA FOR CONSIDERATION BY ENGINEER OF RECORD. CONNECT TO PANEL USING #2 WIRING.
- REFER TO PANEL BOARD SCHEDULES FOR CIRCUIT QUANTITY AND PANEL CONFIGURATION. NUMBER OF SPACES/CIRCUITS VARIES FOR EACH SERVICE.
- 5. COORDINATE WITH CPS ENERGY THE EXTENSION OF 208V, SINGLE PHASE SERVICE LINE FROM THE NEAREST DOWNTOWN UNDERGROUND DISTRIBUTION MANHOLE. CONTRACTOR TO INSTALL UNDERGROUND CONDUIT FROM MANHOLE TO ELECTRICAL SERVICE PEDESTAL AND CONDUIT SLEEVES IN CONCRETE PAD. SERVICE LATERAL CONDUCTORS ARE TO FURNISHED AND INSTALLED BY CPS ENERGY.
- 6. REFER TO PANELBOARD SCHEDULE AND PLANS FOR QUANTITY OF CONTACTORS REQUIRED PER SERVICE.
- 7. REFER TO ELECTRICAL GROUNDING DIAGRAM.
- 3. CONDUCTORS PROVIDED AND INSTALLED BY CONTRACTOR
- 9. COORDINATE WITH CPS ENERGY THE AVAILABLE FAULT CURRENT RATING. ADJUST AIC RATINGS AS REQUIRED TO ACCOMMODATE AVAILABLE FAULT CURRENT.
- 10. BOND NEUTRAL TO GROUND AT THIS LOCATION (GROUND ORIGINATION). REFER TO TYPICAL DUAL METER ONE LINE DIAGRAM.

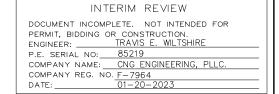


DESCRIPTION

CNG ENGINEERING MEP DESIGN PLANNING COMMISSIONING

1917 N NEW BRAUNFELS AVE, SUITE 201

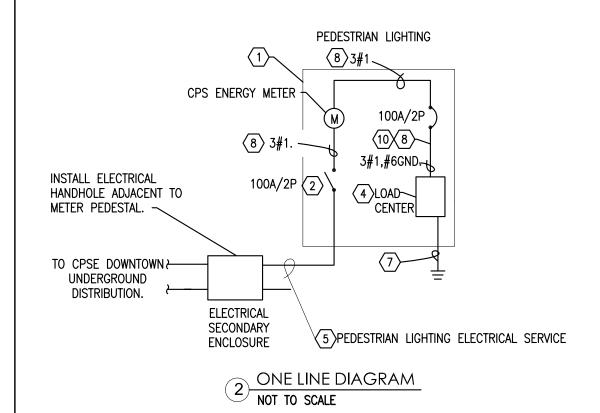

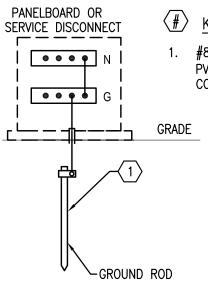

(#) KEYED NOTES: (DETAIL NO. 3 ONLY)

1. #8 COPPER GROUNDING ELECTRODE CONDUCTOR IN PVC TO EXOTHERMIC CONNECTION AT 3/4" x 10' COPPER CLAD STEEL GROUND ROD.



SAN ANTONIO I AUSTIN I HOUSTON I FORT WORTH I DALLAS 2000 NW LOOP 410 I SAN ANTONIO, TX 75213 I 210.375.9000 Texas engineering firm #470 I Texas surveying firm #10028900



V. NO. DATE

CITY OF SAN ANTONIO
PUBLIC WORKS DEPARTMENT


DOLOROSA

ELECTRICAL SERVICE ONE-LINE DIAGRAM SINGLE METER

 DESIGN
 CHECKED
 DRAWN
 PROJECT NO.
 SUBMITTAL
 SHEET NO.

 JC
 JC
 CDC
 23-03763
 70%
 400

3 ELECTRICAL GROUNDING DIAGRAM

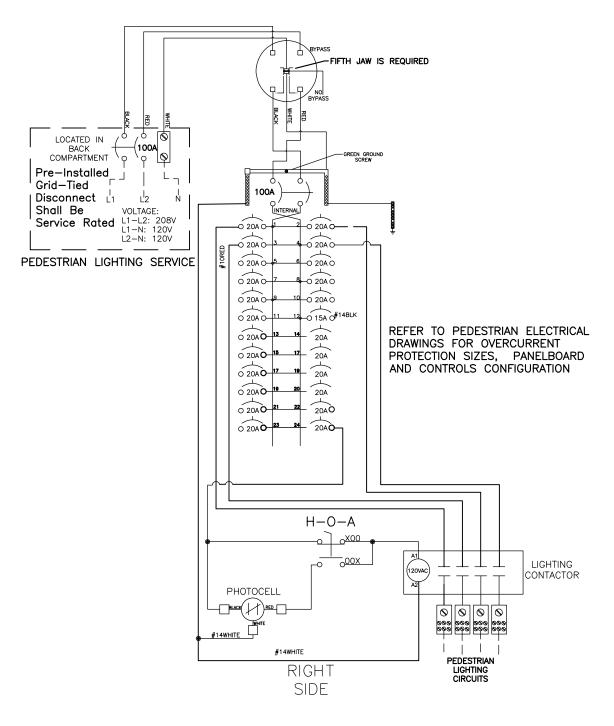

TYPICAL SINGLE METER ONE LINE DIAGRAM NOT TO SCALE

#### INTERIM REVIEW

DOCUMENT INCOMPLETE. NOT INTENDED FOR PERMIT, BIDDING OR CONSTRUCTION.
ENGINEER: TRAVIS E. WILTSHIR

DESCRIPTION REV. NO. DATE



#### CNG ENGINEERING MEP DESIGN | PLANNING | COMMISSIONING 1917 N NEW BRAUNFELS AVE, SUITE 201 SAN ANTONIO, TEXAS 78208 T 210.224.8841 F 210.224.8224

TBPE FIRM # F-7964



SAN ANTONIO I AUSTIN I HOUSTON I FORT WORTH I DALLAS 2000 NW LOOP 410 I SAN ANTONIO, TX 78213 I 210.375.9000 TEXAS ENGINEERING FIRM #470 | TEXAS SURVEYING FIRM #10026800



CITY OF SAN ANTONIO PUBLIC WORKS DEPARTMENT

DOLOROSA

ELECTRICAL SINGLE METER ONE-LINE DIAGRAM

DESIGN	CHECKED	DRAWN	PROJECT NO.	SUBMITTAL	SHEET NO.
JC	JC	CDC	23-03763	70%	401

						Р	ANE	LBC	AF	RD 'E	ES #1	1				
PROJEC	т:	Dolorosa		MAIN	CIRCUIT B	REAKER:	100A			ENC	LOSURE :	NEMA 3R	0	RCPT	5	HEAT
PROJEC	T#:				MAIN LU	GS ONLY:				M	DUNTING:	SURFACE	1	INT LTG	6	A/C
LOCATIO	ON:	CABINET	FENCLOS	JRE	1	BUSSING:	100A			OCI	TYPES:	BOLT-ON	2	EXT LTG	7	KITCH
NOTES		Electrical	I Service No	o. 1	\	OLTAGE:	120/208V,	1-PH, 3-	-W	F	PROVIDE :	NEUTRAL BUS	3	EQPT	8	ELEV
					INTER	RUPTING:	10 kAIC R	MS SYM	l			GROUND BUS	4	FANS	9	EWH
CKT	AMPS	POLE		CIRCUIT DE	SCRIPTION		LOAD	TYPE	PH	TYPE	LOAD	CIRCUIT DESCRIPTION		AMPS	POLE	CKT
1	20	2	DEDEST	DIVNITICH.	TING CIRC	LIIT NO. 1	369	2	Α	0	540	RECEPTACLES		20	1	2
3	20		FEDESII	NAN LIGIT	IIING CIRC	OII NO. I	369	2	В	0	720	RECEPTACLES		20	1	4
5	20	2	DEDEST	DIVN LICH.	TING CIRC	HIT NO 2	402	2	Α	0	540	RECEPTACLES		20	1	6
7	20	2	FEDESTI	MAN LIGIT	IIING CIING	OII NO. Z	402	2	В	0	540	RECEPTACLES		20	1	8
9	20	1		LTG CON	NTACTOR		180	3	Α	0	720	RECEPTACLES		20	1	10
11	20	1		SPA	ARE				В	0	360	RECEPTACLES		20	1	12
13	20	1	SPARE					Α	0	720	RECEPTACLES		20	1	14	
15	20	1	SPARE					В			SPARE		20	1	16	
17	20	1		SPA	ARE				Α			SPARE		20	1	18
19	20	1		SPA	ARE				В			SPARE		20	1	20
21	20	1		SPA	ARE				Α			SPARE		20	1	22
23	20	1		SPA	ARE				В			SPARE		20	1	24
25	20	1		SPA	ARE				Α			SPARE		20	1	26
27	20	1		SPA	ARE				В			SURGE PROTECTION DEVI	CE	60	2	28
29	20	1	IRF	RIGATION (	CONTROLL	.ER	240	3	Α			30KGET KOTECHON DEVI	CL	00		30
			PANEL	SUB	FEED	TOTAL	TOTAL D	EMAND	NOTE	S:						
			VA	FEED	THRU	CONN	VA	AMPS								
	PHASE A	4	3,711	0	0	3,711	3,945	33								
	PHASE E		2,391	0	0	2,391	2,541	21								
	TOTAL 6,101 0 0 6,101				6,486	27	REV	ISIONS:		CNG I	ENGINE	ERING, PL	LLC. R3.	1 - Nov. 4		

E	KIST	ING	PANI	ELBC	ARD	'ES	#3' - 9	936	DO	LOF	ROSA	A ST - PEDESTRIAI	N LIGI	HTI	NG
PROJEC	T:	Dolorosa		MAIN	CIRCUIT B	REAKER:	100A			ENC	LOSURE :	NEMA 3R 0	RCPT	5	HEAT
PROJEC	T#:				MAIN LUG	S ONLY:				M	DUNTING:	SURFACE 1	INT LTG	6	A/C
OCATIO	ON:	CABINE:	Γ ENCLOSI	URE	E	BUSSING:	100A			OCI	P TYPES :	BOLT-ON 2	EXT LTG	7	KITCH
NOTES		Existing	Service (Do	olorosa St)	V	OLTAGE:	120/208V,	1-PH, 3	-W	F	PROVIDE:	NEUTRAL BUS 3	EQPT	8	ELEV
		Electrica	l Service No	o. 3	INTER	RUPTING :	10 kAIC R	MS SYM	1			GROUND BUS 4	FANS	9	EWH
CKT	AMPS	POLE		CIRCUIT DE	SCRIPTION		LOAD	TYPE	PH	TYPE	LOAD	CIRCUIT DESCRIPTION	AMPS	POLE	CKT
1	20	2	EXIG	STING STR	EETLIGHT	ING	532	2	Α	0	360	EXISTING RECEPTACLES	20	1	2
3	20			011110 0111	LLT LIGHT		532	2	В	0	360	EXISTING RECEPTACLES	20	1	4
5	20	2	EXIS	STING STR	EETLIGHT	ING	509	2	Α	0	360	EXISTING RECEPTACLES	20	1	6
7	20			011110 0111			509	2	В	0	360	EXISTING RECEPTACLES	20	1	8
9	20	2	EXIS	STING STR	EETLIGHT	ING	272	2	Α	0	360	EXISTING RECEPTACLES	20	1	10
11	20		ı,	011110 0111			272	2	В	0	360	EXISTING RECEPTACLES	20	1	12
13	20	1		NSTING RE			360	0	Α	4	180	EXISTING LTG CONTACTOR	20	1	14
15	20	1	E	NSTING RE	CEPTACLE	ES	360	0	В	0	540	RECEPTACLES	20	1	16
17	20	1		NSTING RE			180	0	Α	0	360	RECEPTACLES	20	1	18
19	20	1	EXISTING RECEPTACLES		360	0	В	0	540	RECEPTACLES	20	1	20		
21	20	1		NSTING RE			360	0	Α	0	540	RECEPTACLES	20	1	22
23	20	1	E>	NSTING RE	CEPTACLE	S	360	0	В	0	360	RECEPTACLES	20	1	24
25	20	2	PEDEST	RIAN LIGH	TING CIRCI	IIT NO. 3	235	2	Α	0	360	RECEPTACLES	20	1	26
27			1 202011	TWW TT EIGHT		311 110. 0	235	2	В			EXISTING SURGE PROTECTION DEVIC	E 60	2	28
29	20	2	PEDEST	RIAN LIGH	TING CIRCU	JIT NO 4	369	2	Α					_	30
31							369	2	В	0	540	RECEPTACLES	20	1	32
33	20	1	IRF	RIGATION (		ER	240	3	Α	0		BUSSED SPACE	20	1	34
35	20	1		BUSSED				0	В	0		BUSSED SPACE	20	1	36
37	20	1		BUSSED				0	Α	0		BUSSED SPACE	20	1	38
39	20	1		BUSSED				0	В	0		BUSSED SPACE	20	1	40
41	20	1		BUSSED				0	Α	0		BUSSED SPACE	20	1	42
			PANEL	SUB	FEED	TOTAL	TOTAL D		NOTE	S:					
			VA	FEED	THRU	CONN	VA	AMPS							
	PHASE A 5,575 0 0 5,575				,	6,056	50								
	PHASE I	3	6,055	0	0	6,055	6,577	55							
	TOTAL		11,630	0	0	11,630	12,633	53	REV	SIONS:		CNG ENGIN	IEERING, PL	LLC. R3.	1 - Nov.

						Р	ANE	LBC	)AF	RD 'E	ES #2	<b>)</b> '				
PROJEC	CT:	Dolorosa		MAIN	CIRCUIT B	REAKER:	100A			ENC	LOSURE :	NEMA 3R	0	RCPT	5	HEAT
PROJEC	CT # :				MAIN LUG	GS ONLY :				M	DUNTING :	SURFACE	1	INT LTG	6	A/C
LOCATION	ON:	CABINET	T ENCLOSI	JRE		BUSSING :	100A			OCI	P TYPES :	BOLT-ON	2	EXT LTG	7	KITCH
NOTES	:	Upgraded	d/Relocated	I Electrical	Service V	OLTAGE :	120/208V,	1-PH, 3	-W	F	PROVIDE :	NEUTRAL BUS	3	EQPT	8	ELEV
		Electrica	I Service No	o. 2	INTER	RUPTING:	10 kAIC R	MS SYM	1			GROUND BUS	4	FANS	9	EWH
CKT	AMPS	POLE		CIRCUIT DE	SCRIPTION		LOAD	TYPE	PH	TYPE	LOAD	CIRCUIT DESCRIPTION		AMPS	POLE	CKT
1	20	2	DEDECT	DIANTICH	TIME CIDE	LIIT NO. 1	235	2	Α	0	540	RECEPTACLES		20	1	2
3	20		PEDESTRIAN LIGHTING CIRCUIT NO. 1		235	2	В	0	720	RECEPTACLES		20	1	4		
5	20	2	PEDESTRIAN LIGHTING CIRCUIT NO. 2		268	2	Α	0	720	RECEPTACLES		20	1	6		
7	1 20	4	FEDESTRIAN LIGHTING CIRCUIT NO. 2		268	2	В	0	540	RECEPTACLES		20	1	8		
9	20	1	LTG CONTACTOR		180	3	Α			SPARE		20	1	10		
11	20	1	SPARE				В			SPARE		20	1	12		
13	20	1	SPARE				Α			SPARE		20	1	14		
15	20	1		SPA	ARE				В			SPARE		20	1	16
17	20	1		SPA	4RE				Α			SPARE		20	1	18
19	20	1		SPA	ARE				В			SPARE		20	1	20
21	20	1		SPA	ARE				Α			SPARE		20	1	22
23	20	1		SPA	4RE				В			SPARE		20	1	24
25	20	1		SPA	ARE				Α			SPARE		20	1	26
27	20	1		SPA	ARE				В			SURGE PROTECTION DEV	ICE	60	2	28
29	20	1		SPA	ARE				Α			30KGE FROTECTION DEV	ICL	00	2	30
			PANEL	SUB	FEED	TOTAL	TOTAL D	EMAND	NOTE	ES:						
			VA	FEED	THRU	CONN	VA	AMPS								
	PHASE A	4	1,943	0	0	1,943	2,074	17								
	PHASE	3	1,763	0	0	1,763	1,882	16								
	TOTAL 3,705 0 0 3,705				0	3,705	3,956	16	16 REVISIONS: CNG ENGINEERING, PLLC. R3.1 - Nov. 4							



DOCUMENT INCOMPLETE. NOT INTENDED FOR

DOCUMENT INCOMPLETE. NOT INTENDED FOR PERMIT, BIDDING OR CONSTRUCTION.
ENGINEER: TRAVIS E. WILTSHIRE
P.E. SERIAL NO: 85219

COMPANY NAME: CNG ENGINEERING, PLLC.
COMPANY REG. NO. F-7964

DATE: 01-20-2023

REV. NO. DATE DESCRIPTION



CNGENGINEERING
MEP DESIGNI PLANNING I COMMISSIONING
1917 N NEW BRAUNFELS AVE, SUITE 201
SAN ANTONIO, TEXAS 78208
T 210.224.8841 F 210.224.8224 www.cngengineering.com

TBPE FIRM # F-7964



SAN ANTONIO I AUSTIN I HOUSTON I FORT WORTH I DALLAS 2000 NW LOOP 410 I SAN ANTONIO, TX 78213 I 210.375.9000 TEXAS ENGINEERING FIRM #470 | TEXAS SURVEYING FIRM #10028800



CITY OF SAN ANTONIO PUBLIC WORKS DEPARTMENT

DOLOROSA

ELECTRICAL PANEL SCHEDULES

SHEET 1 OF 2

DESIGN CHECKED DRAWN PROJECT NO. SUBMITTAL SHEET NO. JC JC CDC 23-03763 70% 402

E	(IST	ING	PANI	ELBC	ARD	'ES	#4' - 7	720	DO	LOF	ROSA	ST - PEDESTR	IAN	LIGI	HTI	NG
PROJEC	T:	Dolorosa		MAIN	CIRCUIT B	REAKER:	100A			ENC	LOSURE :	NEMA 3R	0	RCPT	5	HEAT
PROJEC	T#:				MAIN LUG	GS ONLY:				M	OUNTING:	SURFACE	1	INT LTG	6	A/C
LOCATIO	N:	CABINE	T ENCLOSU	URE	E	BUSSING:	100A			OC	P TYPES :	BOLT-ON	2	EXT LTG	7	KITCH
NOTES:		Existing	Service (Do	olorosa St)	V	OLTAGE:	120/208V,	1-PH, 3-	-W	1	PROVIDE :	NEUTRAL BUS	3	EQPT	8	ELEV
		Electrica	Service No	o. <b>4</b>	INTER	RUPTING:	10 kAIC R	MS SYM	1			GROUND BUS	4	FANS	9	EWH
CKT	AMPS	POLE		CIRCUIT DE	SCRIPTION		LOAD	TYPE	PH	TYPE	LOAD	CIRCUIT DESCRIPTION		AMPS	POLE	CKT
1	20	2	EVIG	етис ета	REET LIGHT	INC	314	2	Α	0	720	EXISTING RECEPTACLES		20	1	2
3	20	4	LA	31110 3111	CLI LIGITI	ING	314	2	В	0	540	EXISTING RECEPTACLES		20	1	4
5	20	1	E	NSTING RE	CEPTACLI	≣S	360	0	Α	0	720	EXISTING RECEPTACLES		20	1	6
7	20	1	E>	NSTING RE	CEPTACLI	ES	360	0	В							8
9	20	1	E)	NSTING RE	CEPTACLI	≣S	720	0	Α			EXISTING SURGE PROTECTION D	DEVICE	60	3	10
11	20	1	EXI	STING LTC	CONTACT	OR .	180	3	В			1				12
13	20	1	EXISTING LTG CONTACTOR		180	3	Α	0	540	RECEPTACLES		20	1	14		
15	20	2	DEDEST	DIANTICH	TING CIRC	IIT NO 2	335	2	В	0	720	RECEPTACLES		20	1	16
17	20		I LDLS II	INAN LIGIT	TING CINC	JII NO. Z	335	2	Α	0	540	RECEPTACLES		20	1	18
19	20	2	DEDEST	DIANTICH	TING CIRC	IIT NO 3	302	2	В	0	540	RECEPTACLES		20	1	20
21	20		FEDESII	NAN LIGH	IIING CIRCI	JII NO. 3	302	2	Α	0	360	RECEPTACLES		20	1	22
23	20	1		SP	ARE				В	0	360	SPARE		20	1	24
25	20	1		SP	ARE				Α	0	540	SPARE		20	1	26
27	20	1		SP	ARE				В	0	360	SPARE		20	1	28
29	20	1	IRF	RIGATION (	CONTROLL	ER	240		Α	0	540	SPARE		20	1	30
			PANEL	SUB	FEED	TOTAL	TOTAL D	EMAND	NOTE	ES:						
			VA	FEED	THRU	CONN	VA	AMPS								
	PHASE A	4	6,411	0	0	6,411	6,710	56								
	PHASE E	3	4,011	0	0	4,011	<b>4</b> ,198	35								
	TOTAL		10,421	0	0	10,421	10,907	45	REV	ISIONS:		CNG E	NGINE	ERING, PL	LC. R3.	1 - Nov. 4

						Р	ANE	LBC	AF	RD 'I	ES #5	5'				
PROJEC	т:	Dolorosa		MAIN	CIRCUIT B	REAKER:	100A			ENC	LOSURE	: NEMA 3R	0	RCPT	5	HEAT
PROJEC	T#:				MAIN LUG	GS ONLY:				M	OUNTING	: SURFACE	1	INT LTG	6	A/C
LOCATIO	ON :	CABINE	TENCLOS	JRE	E	BUSSING:	100A			OC	P TYPES	: BOLT-ON	2	EXT LTG	7	KITCH
NOTES	:	Electrica	l Service No	o. 5	٧	OLTAGE:	120/208V,	1-PH, 3-	-W	1	PROVIDE	: NEUTRAL BUS	3	EQPT	8	ELEV
					INTER	RUPTING:	10 kAIC R	MS SYN	1			GROUND BUS	4	FANS	9	EWH
CKT	AMPS	POLE		CIRCUIT DE	SCRIPTION		LOAD	TYPE	PH	TYPE	LOAD	CIRCUIT DESCRIPTION		AMPS	POLE	CKT
1	20	2	ререст	DIANTHOLE	TING CIRC	IIT NO 1	268	2	Α	0	720	RECEPTACLES		20	1	2
3	1 20	-	FEDESI	NAN LIGH	IING CIRCI	OII NO. I	268	2	В	0	720	RECEPTACLES		20	1	4
5	20	2	DEDEST	DIVN LICH.	TING CIRC	IIT NO. 2	284	2	Α	0	360	RECEPTACLES		20	1	6
7	] 20	-	LEDESII	NAN LIGIT	TING CINC	OII NO. 2	284	2	В	0	540	RECEPTACLES		20	1	8
9	20	1	LTG CONTACTOR		180	3	Α			SPARE		20	1	10		
11	20	1	SPARE				В			SPARE		20	1	12		
13	20	1	SPARE				Α			SPARE		20	1	14		
15	20	1		SPA	ARE				В			SPARE		20	1	16
17	20	1		SPA	ARE .				Α			SPARE		20	1	18
19	20	1		SPA	ARE				В			SPARE		20	1	20
21	20	1		SPA	ARE				Α			SPARE		20	1	22
23	20	1		SPA	ARE				В			SPARE		20	1	24
25	20	1		SPA	ARE				Α			SPARE		20	1	26
27	20	1			ARE				В			SURGE PROTECTION DEV	ICE	60	2	28
29	20	1	IRF	RIGATION (	CONTROLL	ER.	240	3	Α			30KGET KOTECHON BEV	ICL	00		30
			PANEL	SUB	FEED	TOTAL	TOTAL D	EMAND	NOTE	S:						
			VA	FEED	THRU	CONN	VA	AMPS								
	PHASE A	4	2,052	0	0	2,052	2,198	18								
	PHASE E	3	1,812	0	0	1,812	1,941	16								
	TOTAL		3,863	0	0	3,863	4,139	17	REV	ISIONS:		CNG i	ENGINE	ERING, PL	LC. R3.	1 - Nov. 4

#### INTERIM REVIEW

DOCUMENT INCOMPLETE. NOT INTENDED FOR PERMIT, BIDDING OR CONSTRUCTION.
ENGINEER: TRAVIS E. WILTSHIRE
P.E. SERIAL NO: 85219
COMPANY NAME: CNG ENGINEERING, PLLC.
COMPANY REG. NO. F-7964
DATE: 01-20-2023

REV. NO. DATE DESCRIPTION



## MEP DESIGN PLANNING COMMISSIONING 1917 N NEW BRAUNFELS AVE, SUITE 201 SAN ANTONIO, TEXAS 78208 T 210,224.8941 F 210.224.8224 www.cngengineering.com

TBPE FIRM # F-7964



SAN ANTONIO I AUSTIN I HOUSTON I FORT WORTH I DALLAS 2000 NW LOOP 410 I SAN ANTONIO, TX 78213 I 210.375.9000 TEXAS ENGINEERING FIRM #470 I TEXAS SURVEYING FIRM #10028800




CITY OF SAN ANTONIO PUBLIC WORKS DEPARTMENT

DOLOROSA

ELECTRICAL PANEL SCHEDULES

SHEET 2 OF 2

DESIGN	CHECKED	DRAWN	PROJECT NO.	SUBMITTAL	SHEET NO.
JC	JC	CDC	23-03763	70%	403

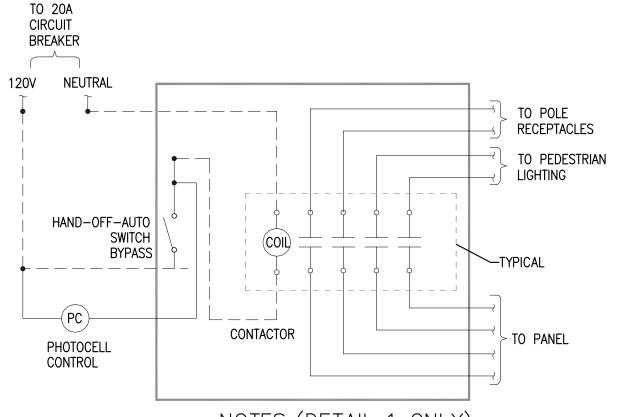

### NOTES: (DETAIL 1 ONLY)

- A. COORDINATE CONTACTOR QUANTITY REQUIREMENTS WITH PLANS.
- B. PROVIDE CONTACTOR IN NEMA 1 ENCLOSURE INSTALLED WITHIN SERVICE
- LIGHTING CONTROL DETAIL NOT TO SCALE

#### INTERIM REVIEW

DOCUMENT INCOMPLETE. NOT INTENDED FOR PERMIT, BIDDING OR CONSTRUCTION.
ENGINEER: TRAVIS E. WILTSHIR

PERMIT, BIDDING
ENGINEER: TRAVIS L. WILLIGHT
P.E. SERIAL NO: 85219
COMPANY NAME: CNG ENGINEERING, PLLC.
COMPANY REG. NO. F-7964
DATE: 01-20-2023

DESCRIPTION REV. NO. DATE



### CNG ENGINEERING MEP DESIGN | PLANNING | COMMISSIONING 1917 N NEW BRAUNFELS AVE, SUITE 201 SAN ANTONIO, TEXAS 78208 T 210.224.8841 F 210.224.8224

TBPE FIRM # F-7964



SAN ANTONIO I AUSTIN I HOUSTON I FORT WORTH I DALLAS 2000 NW LOOP 410 | SAN ANTONIO, TX 78213 | 210.375.9000 TEXAS ENGINEERING FIRM #470 | TEXAS SURVEYING FIRM #10026800




CITY OF SAN ANTONIO PUBLIC WORKS DEPARTMENT


DOLOROSA


ELECTRICAL DETAIL LIGHTING CONTROLS

BMITTAL SHEET NO.	CHECKED DRAWN PROJECT NO.
'0% <b>  404</b>	JC   CDC   23-03763
	JC

					LIGHTING FIXTURE SCHEDULE	
TYPE	LAMPS	MOUNTING	VOLTS	WATTS	DESCRIPTION	MANUFACTURER & MODEL
А	LED 3000K 80 CRI (STD)	POLE	208	67	SILVER FINISH.	LAMP: SELUX MEXTL-TS-S1G3-30-SV-UNV POLE: SELUX MCB-10-DV3G SV-SP-REC2UP

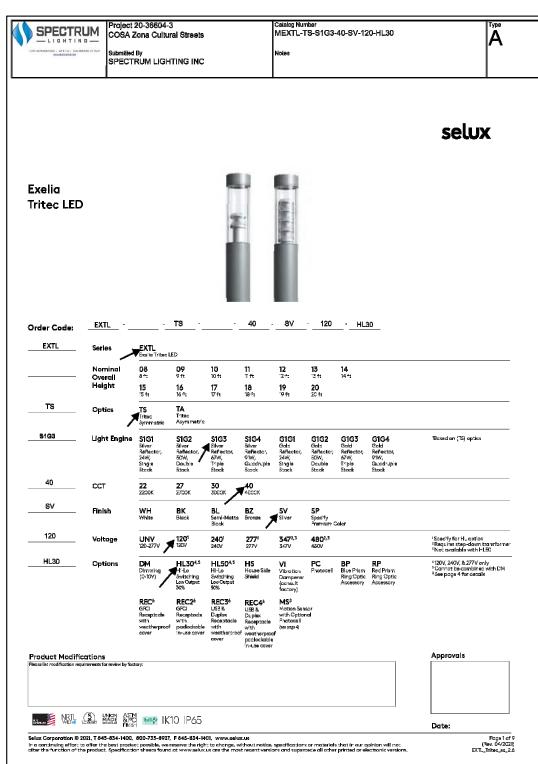

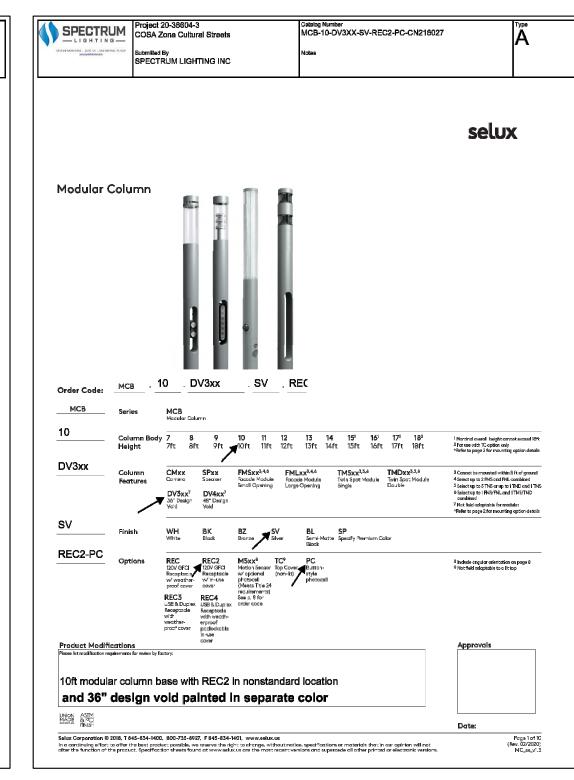

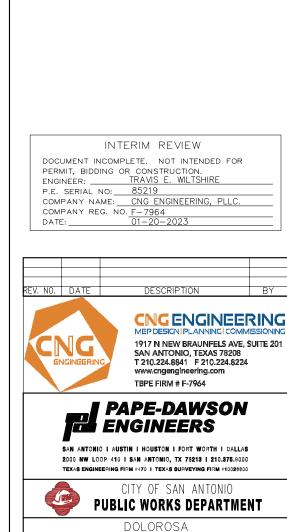


LIGHTING FIXTURE

SCHEDULE AND FIXTURE

CUT SHEET

405

PROJECT NO.

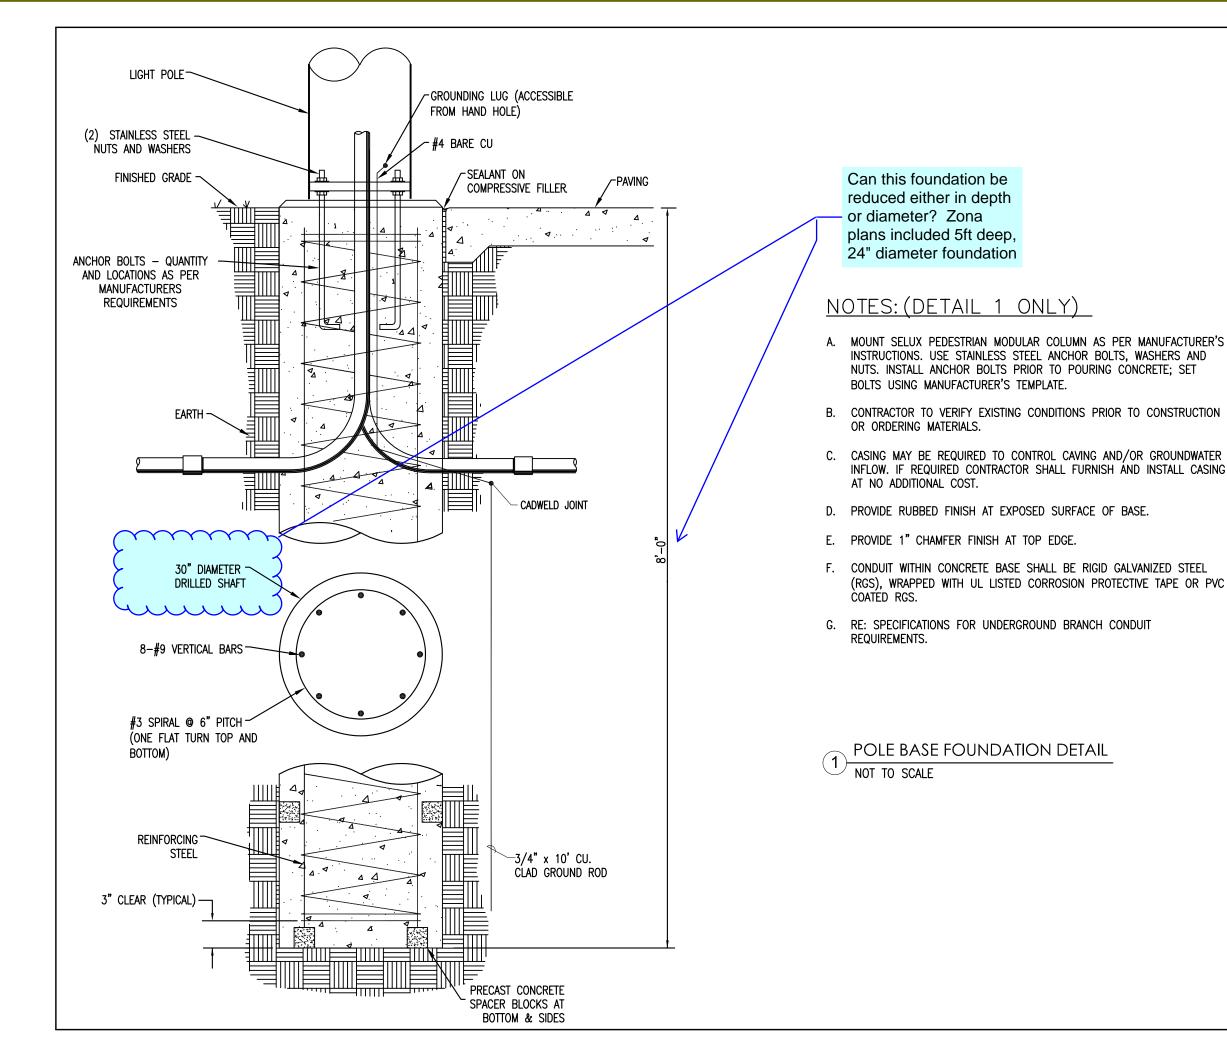

INTERIM REVIEW

DOCUMENT INCOMPLETE. NOT INTENDED FOR

PERMIT, BIDDING OR CONSTRUCTION.
ENGINEER: TRAVIS E. WILTSHIR ENGINEER: TRAVIS E. WILTSHIRE
P.E. SERIAL NO: 85219
COMPANY NAME: CNG ENGINEERING, PLLC.

DESCRIPTION REV. NO. DATE



#### CNG ENGINEERING MEP DESIGN! PLANNING COMMISSIONING 1917 N NEW BRAUNFELS AVE, SUITE 201 SAN ANTONIO, TEXAS 78208 T 210.224.8841 F 210.224.8224

TBPE FIRM # F-7964



SAN ANTONIO I AUSTIN I HOUSTON I FORT WORTH I DALLAS 2000 NW LOOP 410 I SAN ANTONIO, TX 78213 I 210.375.9000 TEXAS ENGINEERING FIRM #470 | TEXAS SURVEYING FIRM #10028800




CITY OF SAN ANTONIO PUBLIC WORKS DEPARTMENT

DOLOROSA

POLE BASE FOUNDATION DETAIL

PROJECT NO. 406

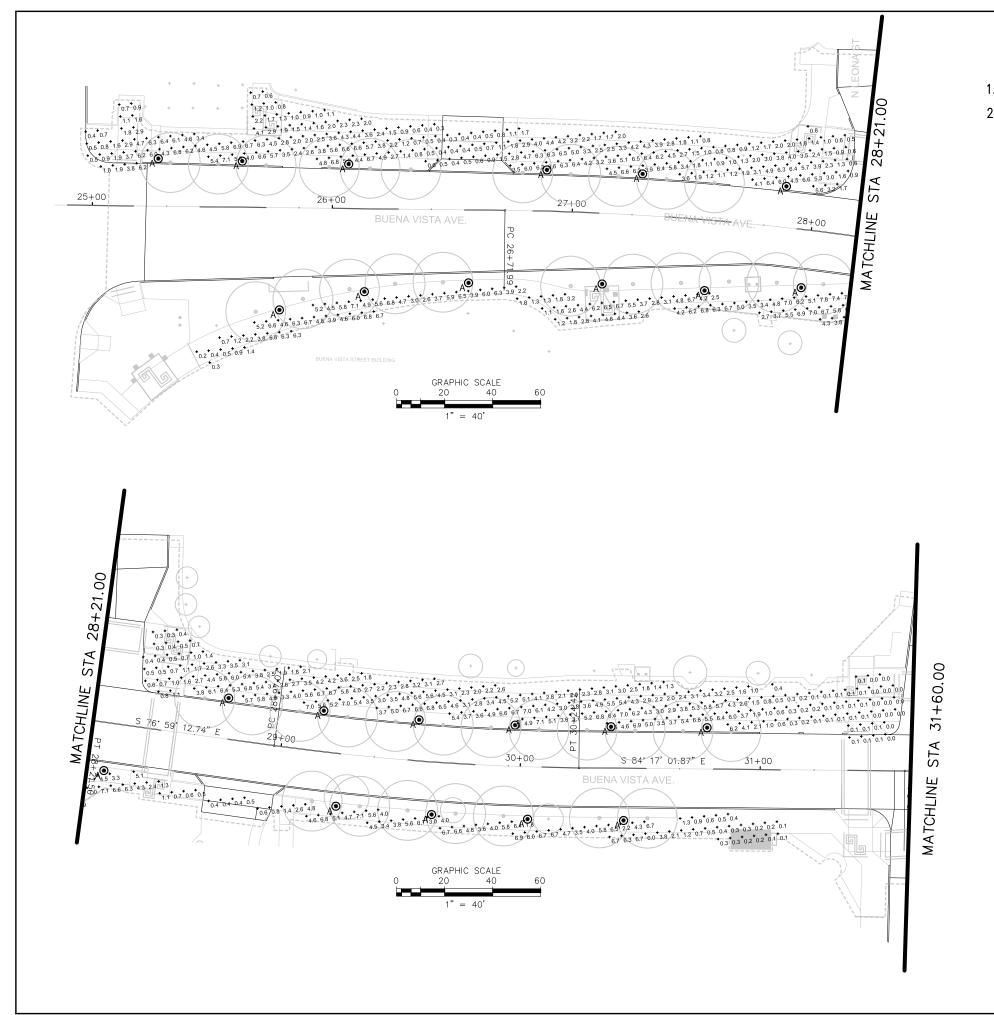

#### **GENERAL NOTES:**

- 1. REFER TO LIGHTING FIXTURE SCHEDULE FOR LUMINAIRE POLES & BOLLARD TYPES.
- PEDESTRIAN LIGHTING LUMINAIRES ARE INTENDED TO ILLUMINATE PEDESTRIAN WALKWAY. ROADWAY ILLUMINATION DESIGN AND SPECIFICATION IS TO BE PROVIDED BY CPS ENERGY.

#### ILLUMINATION LEGEND

PEDESTRIAN LIGHTING POLE



INTERIM REVIEW
DOCUMENT INCOMPLETE. NOT INTENDED FOR
PERMIT, BIDDING OR CONSTRUCTION.
Engineer:TRAVIS E. WILTSHIRE
P.E. SERIAL NO: <u>85219</u>
COMPANY NAME: CNG ENGINEERING, PLLC.
COMPANY REG. NO. F-7964
DATE: 01-21-2023

DESCRIPTION



CNG ENGINEERING MEP DESIGN PLANNING COMMISSIONING 1917 N NEW BRAUNFELS AVE, SUITE 201 SAN ANTONIO, TEXAS 78208 T 210.224.8841 F 210.224.8224 TBPE FIRM # F-7964



SAN ANTONIO I AUSTIN I HOUSTON I FORT WORTH I DALLAS 2000 NW LOOP 410 I SAN ANTONIO, TX 78213 I 210.375.9000 TEXAS ENGINEERING FIRM #470 | TEXAS SURVEYING FIRM #10028800




CITY OF SAN ANTONIO PUBLIC WORKS DEPARTMENT


DOLOROSA

PHOTOMETRIC EXHIBIT

STA BEGIN TO STA 31+60.00

				OTTLL !	· ·
DESIGN	CHECKED	DRAWN	PROJECT NO.	SUBMITTAL	SHEET NO.
JC	JC	CDC	23-03763	70%	407

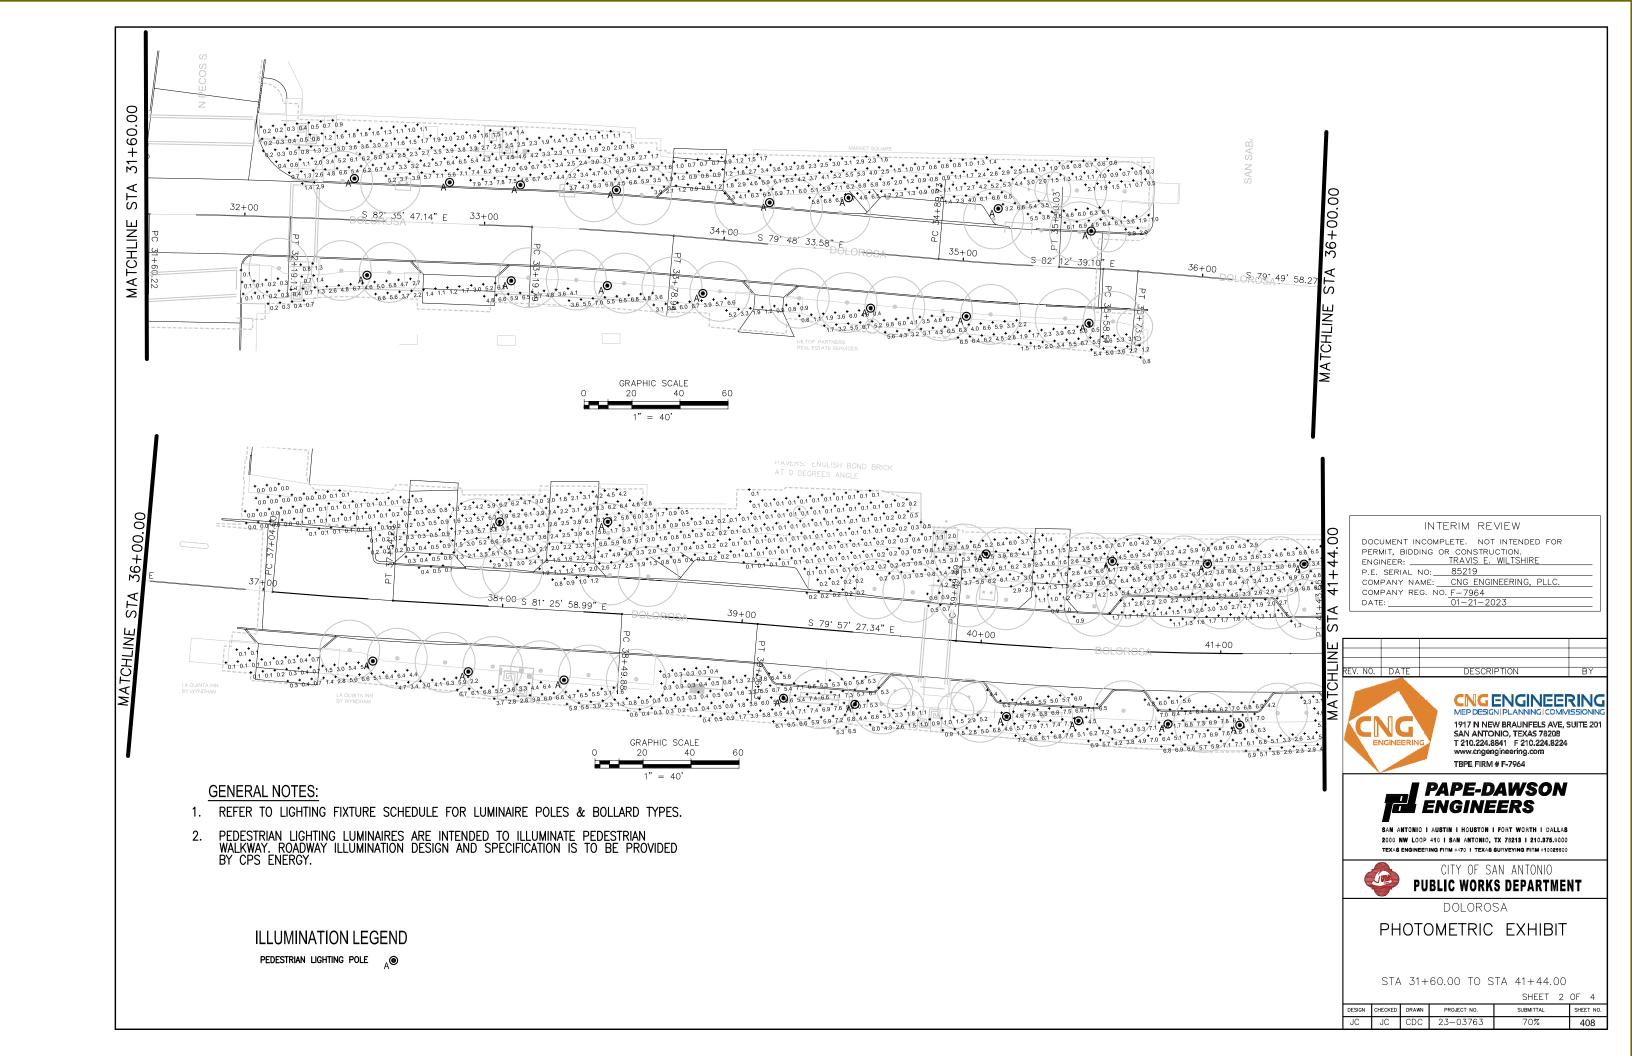

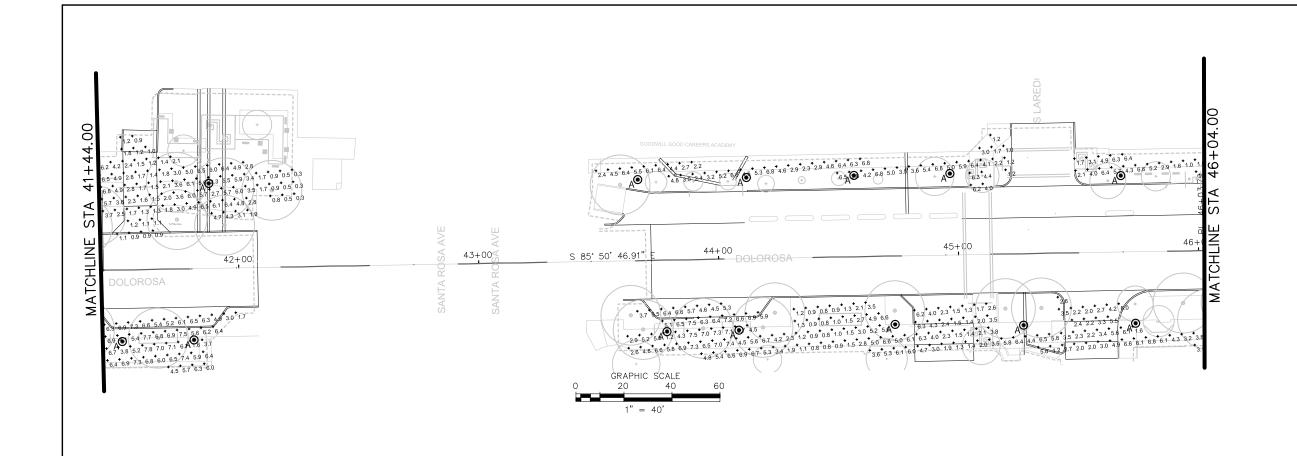

GRAPHIC SCALE 20 40

1" = 40

S 86° 23' 08.80" E

00

04.

STA

MATCHLINE

#### **GENERAL NOTES:**

- 1. REFER TO LIGHTING FIXTURE SCHEDULE FOR LUMINAIRE POLES & BOLLARD TYPES.
- PEDESTRIAN LIGHTING LUMINAIRES ARE INTENDED TO ILLUMINATE PEDESTRIAN WALKWAY. ROADWAY ILLUMINATION DESIGN AND SPECIFICATION IS TO BE PROVIDED BY CPS ENERGY.

#### ILLUMINATION LEGEND

PEDESTRIAN LIGHTING POLE



#### INTERIM REVIEW

DOCUMENT INCOMPLETE. NOT INTENDED FOR PERMIT, BIDDING OR CONSTRUCTION.
ENGINEER: TRAVIS E. WILTSHIRE

P.E. SERIAL NO: 85219

COMPANY NAME: CNG ENGINEERING, PLLC

COMPANY REG. NO. F-7964

DATE: 01-21-2023

DESCRIPTION EV. NO. DATE



CNG ENGINEERING MEP DESIGN PLANNING COMMISSIONING 1917 N NEW BRAUNFELS AVE, SUITE 201 SAN ANTONIO, TEXAS 78208 T 210.224.8841 F 210.224.8224 www.cngengineering.com TBPE FIRM # F-7964



SAN ANTONIO I AUSTIN I HOUSTON I FORT WORTH I DALLAS 2000 NW LOOP 410 | SAN ANTONIO, TX 78213 | 210.375.9000 TEXAS ENGINEERING FIRM #470 | TEXAS SURVEYING FIRM #10029800




CITY OF SAN ANTONIO **PUBLIC WORKS DEPARTMENT** 

DOLOROSA

#### PHOTOMETRIC EXHIBIT

STA 41+44.00 TO STA 47+81.00

				SHEET 3	OF 4
DESIGN	CHECKED	DRAWN	PROJECT NO.	SUBMITTAL	SHEET NO.
JC	JC	CDC	23-03763	70%	409

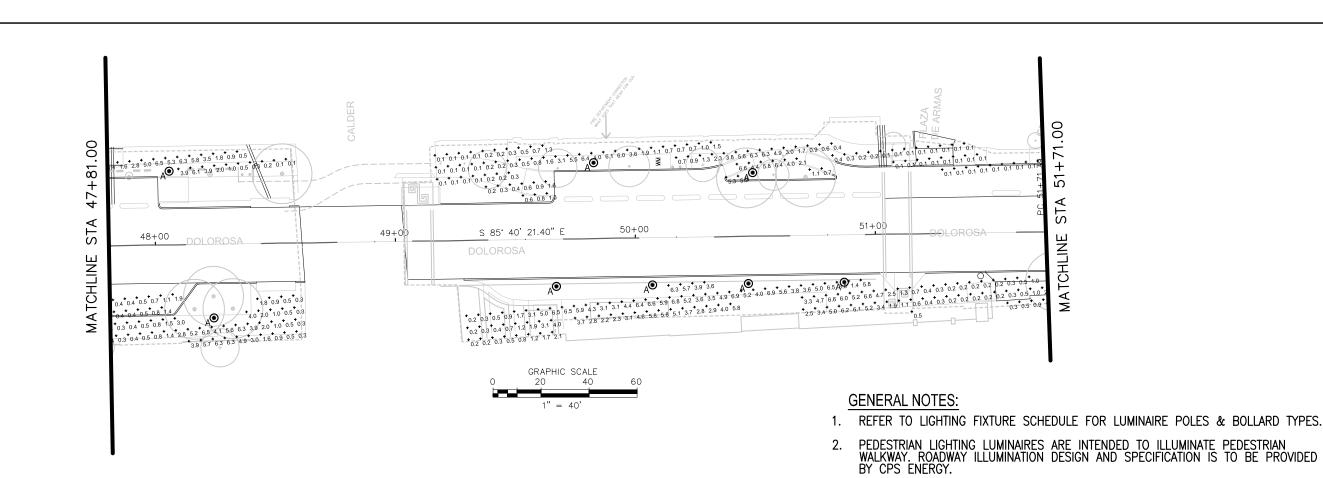

ΔΦ

53+00

GRAPHIC SCALE 20 40 S 89° 03' 10.23" E

8


ST

52+00

0.3 0.2 0.

54+0

# ILLUMINATION LEGEND PEDESTRIAN LIGHTING POLE A®

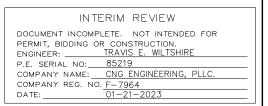





SAN ANTONIO I AUSTIN I HOUSTON I FORT WORTH I DALLAS 2000 NW LOOP 410 I SAN ANTONIO, TX 78213 I 210.375,9000 Texas engineering firm #470 I Texas Surveying firm #1002800



CITY OF SAN ANTONIO
PUBLIC WORKS DEPARTMENT

DOLOROSA

#### PHOTOMETRIC EXHIBIT

STA 47+81.00 TO STA 54+29.00

SHEET 4 OF

				SHEET 4	OF 4
DESIGN	CHECKED	DRAWN	PROJECT NO.	SUBMITTAL	SHEET NO.
JC	JC	CDC	23-03763	70%	410